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PICKERING DESIGN CENTRE (BLOCK 1)

1775 PICKERING PARKWAY PICKERING, ON.

06.037RZ



TURNER FLEISCHER

67 Lesmill Rd Toronto, ON, M3B 2T8 Contact name : Anita Yu Phone Number : 416-425-2222 ext: 235 Email : anita.yu@turnerfleischer.com

ISSUED FOR SPA May 12th, 2022



ODAN DETECH

5230 South Service Road
Unit 107
Burlington, ON, L7L 5K2
Tel:905-632-3811
Contact:Mark Harris
Email:mark@odandetech.com



Studio TLA

20 Champlain Boulevard Suite 102 Toronto, ON, M3H 2Z1 Tel:416-638-4911 Contact:Ray Ronaghan Email:rronaghan@studiotla.ca



HGC Engineering

2000 Argentia Road, Plaza One Suite 203 Mississauga, ON, L5N 1P7 Tel:905-826-4044 Contact:Yvonne Lo Email:ylo@hgcengineering.com



SURVEYING Speight, Van Nostrand & Gibson Limited

750 Oakdale Road Unit 65 & 66 Toronto, ON, M3N 2Z4 Tel:416-749-7866 Contact:Dave Wilton Email:wilton@svng.on.ca



Zelinka Priamo Ltd.

20 Maud Street, Suite 305 Toronto, Ontario M5V 2M5 Tel:416-801-6140 Contact:Robert MacFarlane Email:robert.m@zpplan.com

PROJECT SUMMARY

CITY OF PICKERING ZONING BY-LAW NO.7553/17

GROSS FLOOR AREA DEFINITION

AS PER CITY OF PICKERING ZONING BY-LAW NO.7553/17

"Gross Floor Area" means the total area of each floor whether located above, at or below grade, measured between the exterior faces of the exterior walls of the building at each floor level but excluding any:

(A) porch,

(B) veranda,

(C) cellar,

(D) mechanical room or penthouse, or

(E) reas dedicated to parking within the building.

PROJECT SITE AREA BREAKDOWN

LAND USE	m²	ft²
RIGHT OF WAY	2,580.7	27,779
SITE AREA	9,233.3	99,387
TOTAL NET SITE AREA	11,814.0	127,165.1

PROJECT SITE AREA

SITE AREA	m²	ft²
TOTAL NET SITE AREA	11,814.0	127,165.1
TOTAL PROPOSED GFA	55,945.1	602,188.6
F.S.I OF PROPOSED DEVELOPMENT	4.73 x S	SITE AREA

PROJECT INFORMATION

PROJECT INFORMATION		
	REQUIRED	PROVIDED
BUILDING HEIGHT	-	98.85 M (31 STOREYS)
BUILDING SETBACKS		
NORTH SETBACK	-	8.15 M
SOUTH SETBACK	-	21.84 M
EAST SETBACK	-	18.08 M
WEST SETBACK	1	2.1 M
LOADING SPACE	3	2 TYPE 'G' LOADING SPACE
LOADING SPACE	3	1 TYPE 'B' LOADING SPACE
ESTABLISHED GRADE	9	0.43 M

GROSS FLOOR AREA SUMMARY

BLDG	USE		Gl	-A	FSI
			m²	ft²	
	RETAIL		1,669.0	17,965	0.14
	SUBTOTAL NON-RESIDENTIAL		1,669.0	17,965	0.14
TOWER					
A1+A2	RESIDENTIAL	678 UNITS	52,738.1	567,668	4.46
	INDOOR AMENITY		1,538.0	16,555	0.14
	SUBTOTAL RESIDENTIAL		54,276.1	584,223	4.59
	SUB TOTAL		55,945.1	602,189	4.73
	TOTAL		55,945.1	602,189	4.73

GROSS FLOOR AREA SUMMARY

BLDG	USE		GI	-A	FSI
			m²	ft²	
	RETAIL		1,060.2	11,411	0.08
	SUBTOTAL NON-RESIDENTIAL		1,060.2	11,411	0.09
TOWER					
A1	RESIDENTIAL	346 UNITS	27,432.9	295,286	2.32
	INDOOR AMENITY		851.3	9,163	0.07
	SUBTOTAL RESIDENTIAL		28,284.2	304,449	2.39
	SUB TOTAL		29,344.4	315,860	2.48
	RETAIL		608.9	6,554	0.05
	SUBTOTAL NON-RESIDENTIAL		608.9	6,554	0.05
TOWER					
A2	RESIDENTIAL	332 UNITS	25,305.1	272,382	2.14
	INDOOR AMENITY		686.8	7,392	0.05
	SUBTOTAL RESIDENTIAL		25,991.9	279,775	2.20
	SUB TOTAL		26,600.8	286,328	2.25
	TOTAL		55,945.1	602,189	4.73
				·	·

HEIGHT DEFINITION

"Height" means the vertical distance between the established grade, and in the case of a flat roof, the highest point of the roof surface or parapet wall, or in the case of a mansard roof the deck line, or in the case of a gabled, hip or gambrel roof, the mean height level between the eaves and ridge. When the regulation establishes *height* in *storeys*, means the number of storeys. The height requirements of this By-law shall not apply to roof top mechanical penthouses.

"Grade" or "Established Grade" means the average elevation of the finished level of the ground adjoining all exterior walls of a building.

GROSS FLOOR AREA BREAKDOWN

	FLOOR	# OF UNITS		RESIDE	ENTIAL		TOTAL RES	SIDENTIAL		RET	AIL		TOTAL	RETAIL	INDC AMEN		TOTAL	
		UNITS	SALEA	BLE	NON-SAI	LEABLE			RETA	AIL	RETAIL S	SERVICE			AIVIEI	NII Y	(TFA - EXCL	USIUNS)
			m²	ft²	m²	ft²	m²	ft²	m²	ft²	m²	ft²	m²	ft²	m²	ft²	m²	ft²
	UG 4				346.6	3,731	346.6	3,731									346.6	3,731
	UG 3				346.6	3,731	346.6	3,731									346.6	3,731
	UG 2				346.6	3,731	346.6	3,731									346.6	3,731
	UG 1				346.6	3,731	346.6	3,731									346.6	3,731
	FLOOR 1				653.2	7,031	653.2	7,031	913.2	9,830	146.9	1,582	1,060.2	11,411			1,713.4	18,442
	FLOOR 2	17	1,270.2	13,672	184.7	1,988	1,454.9	15,660									1,454.9	15,660
	FLOOR 3	17	1,270.2	13,672	184.7	1,988	1,454.9	15,660									1,454.9	15,660
	FLOOR 4	17	1,270.2	13,672	184.7	1,988	1,454.9	15,660									1,454.9	15,660
	FLOOR 5	17	1,270.2	13,672	184.7	1,988	1,454.9	15,660									1,454.9	15,660
	FLOOR 6	14	903.7	9,728	187.4	2,017	1,091.2	11,745							205.4	2,210	1,296.5	13,956
	FLOOR 7				82.0	882	82.0	882							645.9	6,953	727.9	7,835
	FLOOR 8	11	680.1	7,320	98.0	1,054	778.0	8,375									778.0	8,375
	FLOOR 9	11	680.1	7,320	98.0	1,054	778.0	8,375									778.0	8,375
	FLOOR 10	11	680.1	7,320	98.0	1,054	778.0	8,375									778.0	8,375
	FLOOR 11	11	680.1	7,320	98.0	1,054	778.0	8,375									778.0	8,375
	FLOOR 12	11	680.1	7,320	98.0	1,054	778.0	8,375									778.0	8,375
	FLOOR 13	11	680.1	7,320	98.0	1,054	778.0	8,375									778.0	8,375
TOWER	FLOOR 14	11	680.1	7,320	98.0	1,054	778.0	8,375									778.0	8,375
A1	FLOOR 15	11	680.1	7,320	98.0	1,054	778.0	8,375									778.0	8,375
, , ,	FLOOR 16	11	658.3	7,086	98.0	1,054	756.3	8,141									756.3	8,141
	FLOOR 17	11	658.3	7,086	98.0	1,054	756.3	8,141									756.3	8,141
	FLOOR 18	11	658.3	7,086	98.0	1,054	756.3	8,141									756.3	8,141
	FLOOR 19	11	658.3	7,086	98.0	1,054	756.3	8,141									756.3	8,141
	FLOOR 20	11	658.3	7,086	98.0	1,054	756.3	8,141									756.3	8,141
	FLOOR 21	11	658.3	7,086	98.0	1,054	756.3	8,141									756.3	8,141
	FLOOR 22	11	658.3	7,086	98.0	1,054	756.3	8,141									756.3	8,141
	FLOOR 23	11	658.3	7,086	98.0	1,054	756.3	8,141									756.3	8,141
	FLOOR 24	11	658.3	7,086	98.0	1,054	756.3	8,141									756.3	8,141
	FLOOR 25	11	658.3	7,086	98.0	1,054	756.3	8,141									756.3	8,141
	FLOOR 26	11	658.3	7,086	98.0	1,054	756.3	8,141									756.3	8,141
	FLOOR 27	11	658.3	7,086	98.0	1,054	756.3	8,141									756.3	8,141
	FLOOR 28	11	658.3	7,086	98.0	1,054	756.3	8,141									756.3	8,141
	FLOOR 29	11	658.3	7,086	98.0	1,054	756.3	8,141									756.3	8,141
	FLOOR 30	11	658.3	7,086	98.0	1,054	756.3	8,141									756.3	8,141
	FLOOR 31	11	658.3	7,086	98.0	1,054	756.3	8,141									756.3	8,141
	M.P.H.			,	75.8	816	75.8	816									75.8	816
																	İ	
	TOTAL	346	21,958.3	236,357	5,474.6	58,928	27,432.9	295,286	913.2	9,830	146.9	1,582	1,060.2	11,411	851.3	9,163	29,344.4	315,860

GROSS FL	OOR AREA BREAKDOW	/N																
	FLOOR	# OF		RESIDE	ENTIAL		TOTAL RE	SIDENTIAL		RET	AIL		TOTAL	RETAIL	INDC		TOTAL	
		UNITS	SALE	ABLE	NON-SAI	EABLE			RET	AIL	RETAIL S	ERVICE			AMEN	NII Y	(TFA - EXCL	USIONS)
			m²	ft²	m²	ft²	m²	ft²	m²	ft²	m²	ft²	m²	ft²	m²	ft²	m²	ft²
	UG 4				233.3	2,511	233.3	2,511									233.3	2,511
	UG 3				233.3	2,511	233.3	2,511									233.3	2,511
	UG 2				192.0	2,067	192.0	2,067									192.0	2,067
	UG 1				206.2	2,220	206.2	2,220			46.3	498	46.3	498			252.5	2,718
	FLOOR 1				412.5	4,440	412.5	4,440	562.6	6,055			562.6	6,055			975.0	10,495
	FLOOR 2	14	984.7	10,599	167.7	1,805	1,152.4	12,404									1,152.4	12,404
	FLOOR 3	14	984.7	10,599	167.7	1,805	1,152.4	12,404									1,152.4	12,404
	FLOOR 4	14	984.7	10,599	167.7	1,805	1,152.4	12,404									1,152.4	12,404
	FLOOR 5	14	984.7	10,599	167.7	1,805	1,152.4	12,404									1,152.4	12,404
	FLOOR 6	12	757.0	8,148	169.6	1,825	926.5	9,973							120.7	1,300	1,047.3	11,273
	FLOOR 7				82.0	882	82.0	882							566.0	6,093	648.0	6,975
	FLOOR 8	11	680.1	7,321	97.9	1,054	778.1	8,375									778.1	8,375
	FLOOR 9	11	680.1	7,321	97.9	1,054	778.1	8,375									778.1	8,375
	FLOOR 10	11	680.1	7,321	97.9	1,054	778.1	8,375									778.1	8,375
	FLOOR 11	11	680.1	7,321	97.9	1,054	778.1	8,375									778.1	8,375
	FLOOR 12	11	680.1	7,321	97.9	1,054	778.1	8,375									778.1	8,375
	FLOOR 13	11	680.1	7,321	97.9	1,054	778.1	8,375									778.1	8,375
TOWER	FLOOR 14	11	680.1	7,321	97.9	1,054	778.1	8,375									778.1	8,375
A2	FLOOR 15	11	680.1	7,321	97.9	1,054	778.1	8,375									778.1	8,375
	FLOOR 16	11	658.9	7,093	97.9	1,054	756.9	8,147									756.9	8,147
	FLOOR 17	11	658.9	7,093	97.9	1,054	756.9	8,147									756.9	8,147
	FLOOR 18	11	658.9	7,093	97.9	1,054	756.9	8,147									756.9	8,147
	FLOOR 19	11	658.9	7,093	97.9	1,054	756.9	8,147									756.9	8,147
	FLOOR 20	11	658.9	7,093	97.9	1,054	756.9	8,147									756.9	8,147
	FLOOR 21	11	658.9	7,093	97.9	1,054	756.9	8,147									756.9	8,147
	FLOOR 22	11	658.9	7,093	97.9	1,054	756.9	8,147									756.9	8,147
	FLOOR 23	11	658.9	7,093	97.9	1,054	756.9	8,147									756.9	8,147
	FLOOR 24	11	658.9	7,093	97.9	1,054	756.9	8,147									756.9	8,147
	FLOOR 25	11	658.9	7,093	97.9	1,054	756.9	8,147									756.9	8,147
	FLOOR 26	11	658.9	7,093	97.9	1,054	756.9	8,147									756.9	8,147
	FLOOR 27	11	658.9	7,093	97.9	1,054	756.9	8,147									756.9	8,147
	FLOOR 28	11	658.9	7,093	97.9	1,054	756.9	8,147									756.9	8,147
	FLOOR 29	11	658.9	7,093	97.9	1,054	756.9	8,147									756.9	8,147
	FLOOR 30	11	658.9	7,093	97.9	1,054	756.9	8,147									756.9	8,147
	FLOOR 31	11	658.9	7,093	97.9	1,054	756.9	8,147									756.9	8,147
	M.P.H.				75.8	816	75.8	816									75.8	816
	TOTAL	332	20,679.7	222,595	4,625.4	49,788	25,305.1	272,382	562.6	6,055	46.3	498	608.9	6,554	686.8	7,392	26,600.8	286,328

AMENITY AREA

MENITY A REAKDOV			OTAL FLO	OR AREA		
OUTE		,	AREA EXC	CLUSIONS	TOTAL FLO	OOR AR
AME	NIIY				GFA+IN AMENIT	
m²	ft²		m²	ft²	m²	ft²
			3,211.9	34,573	3,558.5	38,
			3,211.9	34,573	3,558.5	38,
			3,211.9	34,573	3,558.5	38,
			3,165.6	34,074	3,512.2	37,
			1.8	19	1,715.1	18,
			6.0	64	1,460.9	15,
			6.0	64	1,460.9	15,
			6.0	64	1,460.9	15,
			6.0	64	1,460.9	15,
			6.0	64	1,302.5	14,
610.3	6,570		6.0	64	733.9	7,
			6.0	64	784.0	8,
			6.0	64	784.0	8,
			6.0	64	784.0	8,
			6.0	64	784.0	8,
			6.0	64	784.0	8,
			6.0	64	784.0	8,
			6.0	64	784.0	8,
			6.0	64	784.0	8,
			6.0	64	762.2	8,
			6.0	64	762.2	8,
			6.0 230.4	2,480	762.2 306.2	8,
			230.4	2,400	300.2	3,
610.3	6,570		13,214.4	142,239	42,558.7	458,

441.2	4,749	14,092.2	151,687	40,692.9	
		230.4	2,480	306.2	3,29
		6.0	64	762.8	8,21
		6.0	64	762.8	8,21
		6.0	64	784.0	8,43
		6.0	64	784.0	8,43
		6.0	64	784.0	8,43
		6.0	64	784.0	8,43
		6.0	64	784.0	8,43
		6.0	64	784.0	8,43
		6.0	64	784.0	8,43 8,43
441.2	4,749	6.0	64 64	654.0 784.0	7,03
444.0	4.740	6.0	64	1,053.3	11,33
		6.0	64	1,158.4	12,46
		6.0	64	1,158.4	12,46
		6.0	64	1,158.4	12,46
		6.0	64	1,158.4	12,46
		66.9	720	1,041.9	11,21
		3,413.9	36,747	3,666.4	39,46
		3,428.0	36,899	3,620.1	38,96
		3,386.8	36,455	3,620.1	38,96
		3,386.8	36,455	3,620.1	38,96
m²	ft²	m²	ft²	m²	ft²
AMEN	NII Y			GFA+INI AMENITY	
		AREA EXC	CLUSIONS	TOTAL FLO	OR AREA
OUTD	$\cap \cap P$				

TURNER FLEISCHER

67 Lesmill Road Toronto, ON, M3B 2T8

T 416 425 2222 This drawing, as an instrument of service, is provided by and is the property of Turner Fleischer Architects Inc. The contractor must verify and accept responsibility for all dimensions and conditions on site and must notify Turner Fleischer Architects Inc. of any variations from the supplied information. This drawing is not to be scaled. The architect is not responsible for the accuracy of survey, structural, mechanical, electrical, etc., information shown on this drawing. Refer to the appropriate consultant's drawings before proceeding with the work. Construction must conform to all applicable codes and requirements of authorities having jurisdiction. The contractor working from drawings not specifically marked 'For Construction' must assume full responsibility and bear costs for any corrections or damages resulting from his work.

DATE DESCRIPTION



PICKERING DESIGN CENTRE (BLOCK 1)

1775 PICKERING PARKWAY PICKERING, ON.

STATISTICS P1

2022-05-12 TKA CHECKED BY

AYU

SALEABLE UNIT MIX PROVIDED

BLDG	FLOOR								TOTAL	AVG. UN	IIT SIZE
		STUDIO	1B	1B+D	2B	2B+D	3B	3B+D		m²	ft²
	FLOOR 2	1	5	4	2	7	10	2	31	72.7	783
	FLOOR 3	1	5	4	2	7	10	2	31	72.7	783
	FLOOR 4	1	5	4	2	7	10	2	31	72.7	783
	FLOOR 5	1	5	4	2	7	10	2	31	72.7	783
	FLOOR 6	1	5	7	2	6	5		26	63.9	688
	FLOOR 8		4	10	2	2	4		22	61.8	666
	FLOOR 9		4	10	2	2	4		22	61.8	666
	FLOOR 10		4	10	2	2	4		22	61.8	666
	FLOOR 11		4	10	2	2	4		22	61.8	666
	FLOOR 12		4	10	2	2	4		22	61.8	666
	FLOOR 13		4	10	2	2	4		22	61.8	666
	FLOOR 14		4	10	2	2	4		22	61.8	666
	FLOOR 15		4	10	2	2	4		22	61.8	666
	FLOOR 16	2	2	9	4	5			22	59.9	644
	FLOOR 17	2	2	9	4	5			22	59.9	644
	FLOOR 18	2	2	9	4	5			22	59.9	644
	FLOOR 19	2	2	9	4	5			22	59.9	644
TOWER A1+A2	FLOOR 20	2	2	9	4	5			22	59.9	644
7 (1 - 7 12	FLOOR 21	2	2	9	4	5			22	59.9	644
	FLOOR 22	2	2	9	4	5			22	59.9	644
	FLOOR 23	2	2	9	4	5			22	59.9	644
	FLOOR 24	2	2	9	4	5			22	59.9	644
	FLOOR 25	2	2	9	4	5			22	59.9	644
	FLOOR 26	2	2	9	4	5			22	59.9	644
	FLOOR 27	2	2	9	4	5			22	59.9	644
	FLOOR 28	2	2	9	4	5			22	59.9	644
	FLOOR 29	2	2	9	4	5			22	59.9	644
	FLOOR 30	2	2	9	4	5			22	59.9	644
	FLOOR 31	2	2	9	4	5			22	59.9	644
	SUBTOTAL	37	89	247	90	130	77	8	678		
	TOTAL UNITS	37	33	36	22	20	8	5	070		
	UNIT MIX	5.5%	13.1%	36.4%	13.3%	19.2%	11.4%	1.2%	100.0%	62.9	677
	UNIT MIX TOTAL	5.5%	49.	6%	32.	4%	12.	5%	100.0%	02.3	011
	AVG UNIT SIZE	39.9	43.2	59.2	63.1	71.8	89.3	100.8	m²		
	AVG UNIT SIZE TOTAL	39.9	55	5.0	68	3.2	90).3	m²		

AMENITY AREAS REQUIRED & PROVIDED

	TYPE	R	REQUIRED		P	ROVIDED	
		RATIO	m²	ft²	RATIO	m²	ft²
TOWER	INDOOR AMENITY	2.00 m²/UNIT	692.00	7,449	2.46 m²/UNIT	851.28	9,163
A1	OUTDOOR AMENITY	2.00 m²/UNIT	692.00	7,449	1.76 m²/UNIT	610.34	6,570
	TOTAL AMENITY	4.00 m²/UNIT	1,384.00	14,897	4.22 m²/UNIT	1,461.63	15,733

AMENITY AREAS REQUIRED & PROVIDED

AIVICINI I F	ANEAS NEQUINED & FIN	VIDED					
	TYPE	R	REQUIRED		P	ROVIDED	
		RATIO	m²	ft²	RATIO	m²	ft²
TOWER	INDOOR AMENITY	2.00 m²/UNIT	664.00	7,147	2.06 m²/UNIT	686.76	7,392
A2	OUTDOOR AMENITY	2.00 m²/UNIT	664.00	7,147	1.32 m²/UNIT	441.16	4,749
	TOTAL AMENITY	4.00 m²/UNIT	1,328.00	14,294	3.39 m²/UNIT	1,127.92	12,141

SALEABLE UNIT MIX REQUIRED

									TOTAL
		STUDIO	1B	1B+D	2B	2B+D	3B	3B+D	
TOWER	RATIO	5.0%	15.0%	20.0%	30.0%	20.0%	10.0%		100.0%
A1+A2	COUNT	32	95	126	189	126	62		630

SALEABLE UNIT MIX PROVIDED - UNIT TOTALS

	BLDG								TOTAL	AVG. UN	IIT SIZE
		STUDIO	1B	1B+D	2B	2B+D	3B	3B+D		m²	ft²
	A1	16	47	148	29	59	43	4	346	63.5	683
	A2	21	42	99	61	71	34	4	332	62.3	670
TOWER	SUBTOTAL	37	89	247	90	130	77	8	678		
A1+A2	TOTAL UNITS	37	33	36	22	20	8	5	676		
	UNIT MIX	5.5%	13.1%	36.4%	13.3%	19.2%	11.4%	1.2%	100.0%	62.9	677
	UNIT MIX TOTAL	5.5%	49.	6%	32.4%		12.5%		100.0%	62.9	677
	AVG UNIT SIZE	39.9	43.2	59.2	63.1	71.8	89.3	100.8	m²		
	AVG UNIT SIZE TOTAL	39.9	55	5.0	68	3.2	90).3	m²		

SALEABLE UNIT MIX PROVIDED

BLDG	FLOOR							TOTAL	AVG. UN	IT SIZE	
		STUDIO	1B	1B+D	2B	2B+D	3B	3B+D		m²	ft²
	FLOOR 2		3	2	1	4	6	1	17	74.7	804
	FLOOR 3		3	2	1	4	6	1	17	74.7	804
	FLOOR 4		3	2	1	4	6	1	17	74.7	804
	FLOOR 5		3	2	1	4	6	1	17	74.7	804
	FLOOR 6		3	4	1	3	3		14	64.6	695
	FLOOR 8		2	5	1	1	2		11	61.8	665
	FLOOR 9		2	5	1	1	2		11	61.8	665
	FLOOR 10		2	5	1	1	2		11	61.8	665
	FLOOR 11		2	5	1	1	2		11	61.8	665
	FLOOR 12		2	5	1	1	2		11	61.8	665
	FLOOR 13		2	5	1	1	2		11	61.8	665
	FLOOR 14		2	5	1	1	2		11	61.8	665
	FLOOR 15		2	5	1	1	2		11	61.8	665
	FLOOR 16	1	1	6	1	2			11	59.8	644
	FLOOR 17	1	1	6	1	2			11	59.8	644
	FLOOR 18	1	1	6	1	2			11	59.8	644
	FLOOR 19	1	1	6	1	2			11	59.8	644
TOWER	FLOOR 20	1	1	6	1	2			11	59.8	644
A1	FLOOR 21	1	1	6	1	2			11	59.8	644
	FLOOR 22	1	1	6	1	2			11	59.8	644
	FLOOR 23	1	1	6	1	2			11	59.8	644
	FLOOR 24	1	1	6	1	2			11	59.8	644
	FLOOR 25	1	1	6	1	2			11	59.8	644
	FLOOR 26	1	1	6	1	2			11	59.8	644
	FLOOR 27	1	1	6	1	2			11	59.8	644
	FLOOR 28	1	1	6	1	2			11	59.8	644
	FLOOR 29	1	1	6	1	2			11	59.8	644
	FLOOR 30	1	1	6	1	2			11	59.8	644
	FLOOR 31	1	1	6	1	2			11	59.8	644
				!		!		!		<u>'</u>	
	SUBTOTAL	16	47	148	29	59	43	4	3/6		
	TOTAL UNITS	16	19	95	8	18	4	17	346		.5 683
	UNIT MIX	4.6%	13.6%	42.8%	8.4%	17.1%	12.4%	1.2%	100.0%	62.5	
	UNIT MIX TOTAL	4.6%	56.	.4%	25	4%	13	.6%	100.0%	63.5	003
	AVG UNIT SIZE	40.1	43.2	59.9	63.8	72.2	91.4	94.9	m²		
	AVG UNIT SIZE TOTAL	40.1	55	5.9	69	9.4	9	1.7	m²		

SALEABLE UNIT MIX PROVIDED

BLDG	FLOOR								TOTAL	AVG. UN	IIT SIZE
		STUDIO	1B	1B+D	2B	2B+D	3B	3B+D		m²	ft²
	FLOOR 2	1	2	2	1	3	4	1	14	70.3	757
	FLOOR 3	1	2	2	1	3	4	1	14	70.3	757
	FLOOR 4	1	2	2	1	3	4	1	14	70.3	757
	FLOOR 5	1	2	2	1	3	4	1	14	70.3	757
	FLOOR 6	1	2	3	1	3	2		12	63.1	679
	FLOOR 8		2	5	1	1	2		11	61.8	666
	FLOOR 9		2	5	1	1	2		11	61.8	666
	FLOOR 10		2	5	1	1	2		11	61.8	666
	FLOOR 11		2	5	1	1	2		11	61.8	666
	FLOOR 12		2	5	1	1	2		11	61.8	666
	FLOOR 13		2	5	1	1	2		11	61.8	666
	FLOOR 14		2	5	1	1	2		11	61.8	666
	FLOOR 15		2	5	1	1	2		11	61.8	666
	FLOOR 16	1	1	3	3	3			11	59.9	645
	FLOOR 17	1	1	3	3	3			11	59.9	645
	FLOOR 18	1	1	3	3	3			11	59.9	645
	FLOOR 19	1	1	3	3	3			11	59.9	645
TOWER	FLOOR 20	1	1	3	3	3			11	59.9	645
A2	FLOOR 21	1	1	3	3	3			11	59.9	645
	FLOOR 22	1	1	3	3	3			11	59.9	645
	FLOOR 23	1	1	3	3	3			11	59.9	645
	FLOOR 24	1	1	3	3	3			11	59.9	645
	FLOOR 25	1	1	3	3	3			11	59.9	645
	FLOOR 26	1	1	3	3	3			11	59.9	645
	FLOOR 27	1	1	3	3	3			11	59.9	645
	FLOOR 28	1	1	3	3	3			11	59.9	645
	FLOOR 29	1	1	3	3	3			11	59.9	645
	FLOOR 30	1	1	3	3	3			11	59.9	645
	FLOOR 31	1	1	3	3	3			11	59.9	645
	SUBTOTAL	21	42	99	61	71	34	4	332		
	TOTAL UNITS	21		41		32		8			
	UNIT MIX	6.3%	12.7%	29.8%	18.4%	21.4%	10.2%	1.2%	100.0%	62.3	670
	UNIT MIX TOTAL	6.3%		5%		.8%		4%	100.0%	32.0	670
	AVG UNIT SIZE	39.8	43.2	58.2	62.8	71.5	86.5	106.7	m²		
	AVG UNIT SIZE TOTAL	39.8	53	3.7	67	7.4	88	3.6	m²		

VEHICULAR PARKING - MINIMUM REQUIRED

	USE	RATIO (MIN.)	UNITS / GFA (m²)	SPACES (MIN.)
	VISITOR	0.15 / UNIT	678	101
	STUDIO UNITS	0.80 / UNIT	37	29
TOWER	1B & 1B+D UNITS	0.80 / UNIT	336	268
A1+A2	2B & 2B+D UNITS	0.80 / UNIT	220	176
	3B & 3B+D UNITS	0.80 / UNIT	85	68
	RETAIL	3.50/100 m ²	1669	58
	TOTAL	700		

VEHICULAR PARKING PROVIDED

VEHICOET (174 (MINO 11 NO VIBED								
	FLOOR		USE		TOTAL			
	FLOOR	RETAIL	VISITOR	RESIDENTIAL				
	FLOOR 1	3			3			
TOWER	UG 1	56	97	4	157			
A1+A2	UG 2			160	160			
	UG 3			168	168			
	UG 4			171	171			
	TOTAL	59	97	503	659			
	•							

BICYCLE PARKING - MINIMUM REQUIRED (AS PER CITY OF PICKERING BY-LAW 7553/17)

	RESIDENT	ΓIAL	RETAI	L	TOTAL
	RATIO	SPACES	RATIO	SPACES	IOIAL
TOWED					
TOWER A1+ A2	0.50 / UNIT	315	1/1000 m ²	2	3
AIT AZ					
		315		2	317

BICYCLE PARKING PROVIDED

		110	\ -		
	FLOOR	US	bE	TOTAL	
	FLOOR	RETAIL	RESIDENTIAL		
TOWER	LEVEL 1	10	228	238	
TOWER A1+A2	UG 1		60	60	
71172	UG 2		27	27	
	UG 3				
	TOTAL	10	315	325	

50% OF BICYCLE PARKING TO BE VERTICAL, THE REST MUST BE HORIZONTAL. 25% MUST BE LOCATED WITHIN:

1) A BUILDING OR STRUCTURE

2) A SECURE AREA (SUPERVISED PARKING LOT OR ENCLOSURE)

3) BICYCLE LOCKERS

ACCESSIBLE PARKING - MINIMUM REQUIRED (AS PER CITY OF PICKERING BY-LAW 7553/17)

	USE	RATIO (MIN.)	SPACES (MIN.)
TOWER	VISITOR	8 PARKING SPACES/ 401-800 TOTAL SPACES	8
A1+A2	RESIDENTIAL	8 PARKING SPACES/ 401-800 TOTAL SPACES	8
	TOTAL	16	

ACCESSIBLE PARKING PROVIDED

	FLOOR	US	SE .	TOTAL	
	FLOOR	VISITOR	RESIDENTIAL	TOTAL	
TOWER	LEVEL 1				
TOWER A1+A2	UG 1	8		8	
ATTAL	UG 2		8	8	
	UG 3				
	UG 4				
	TOTAL	8	8	16	

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DATE DESCRIPTION




PICKERING DESIGN CENTRE (BLOCK 1)

1775 PICKERING PARKWAY PICKERING, ON.

STATISTICS P2

PROJECT NO. 06.037RZ PROJECT DATE 2022-05-12 DRAWN BY TKA CHECKED BY AYU



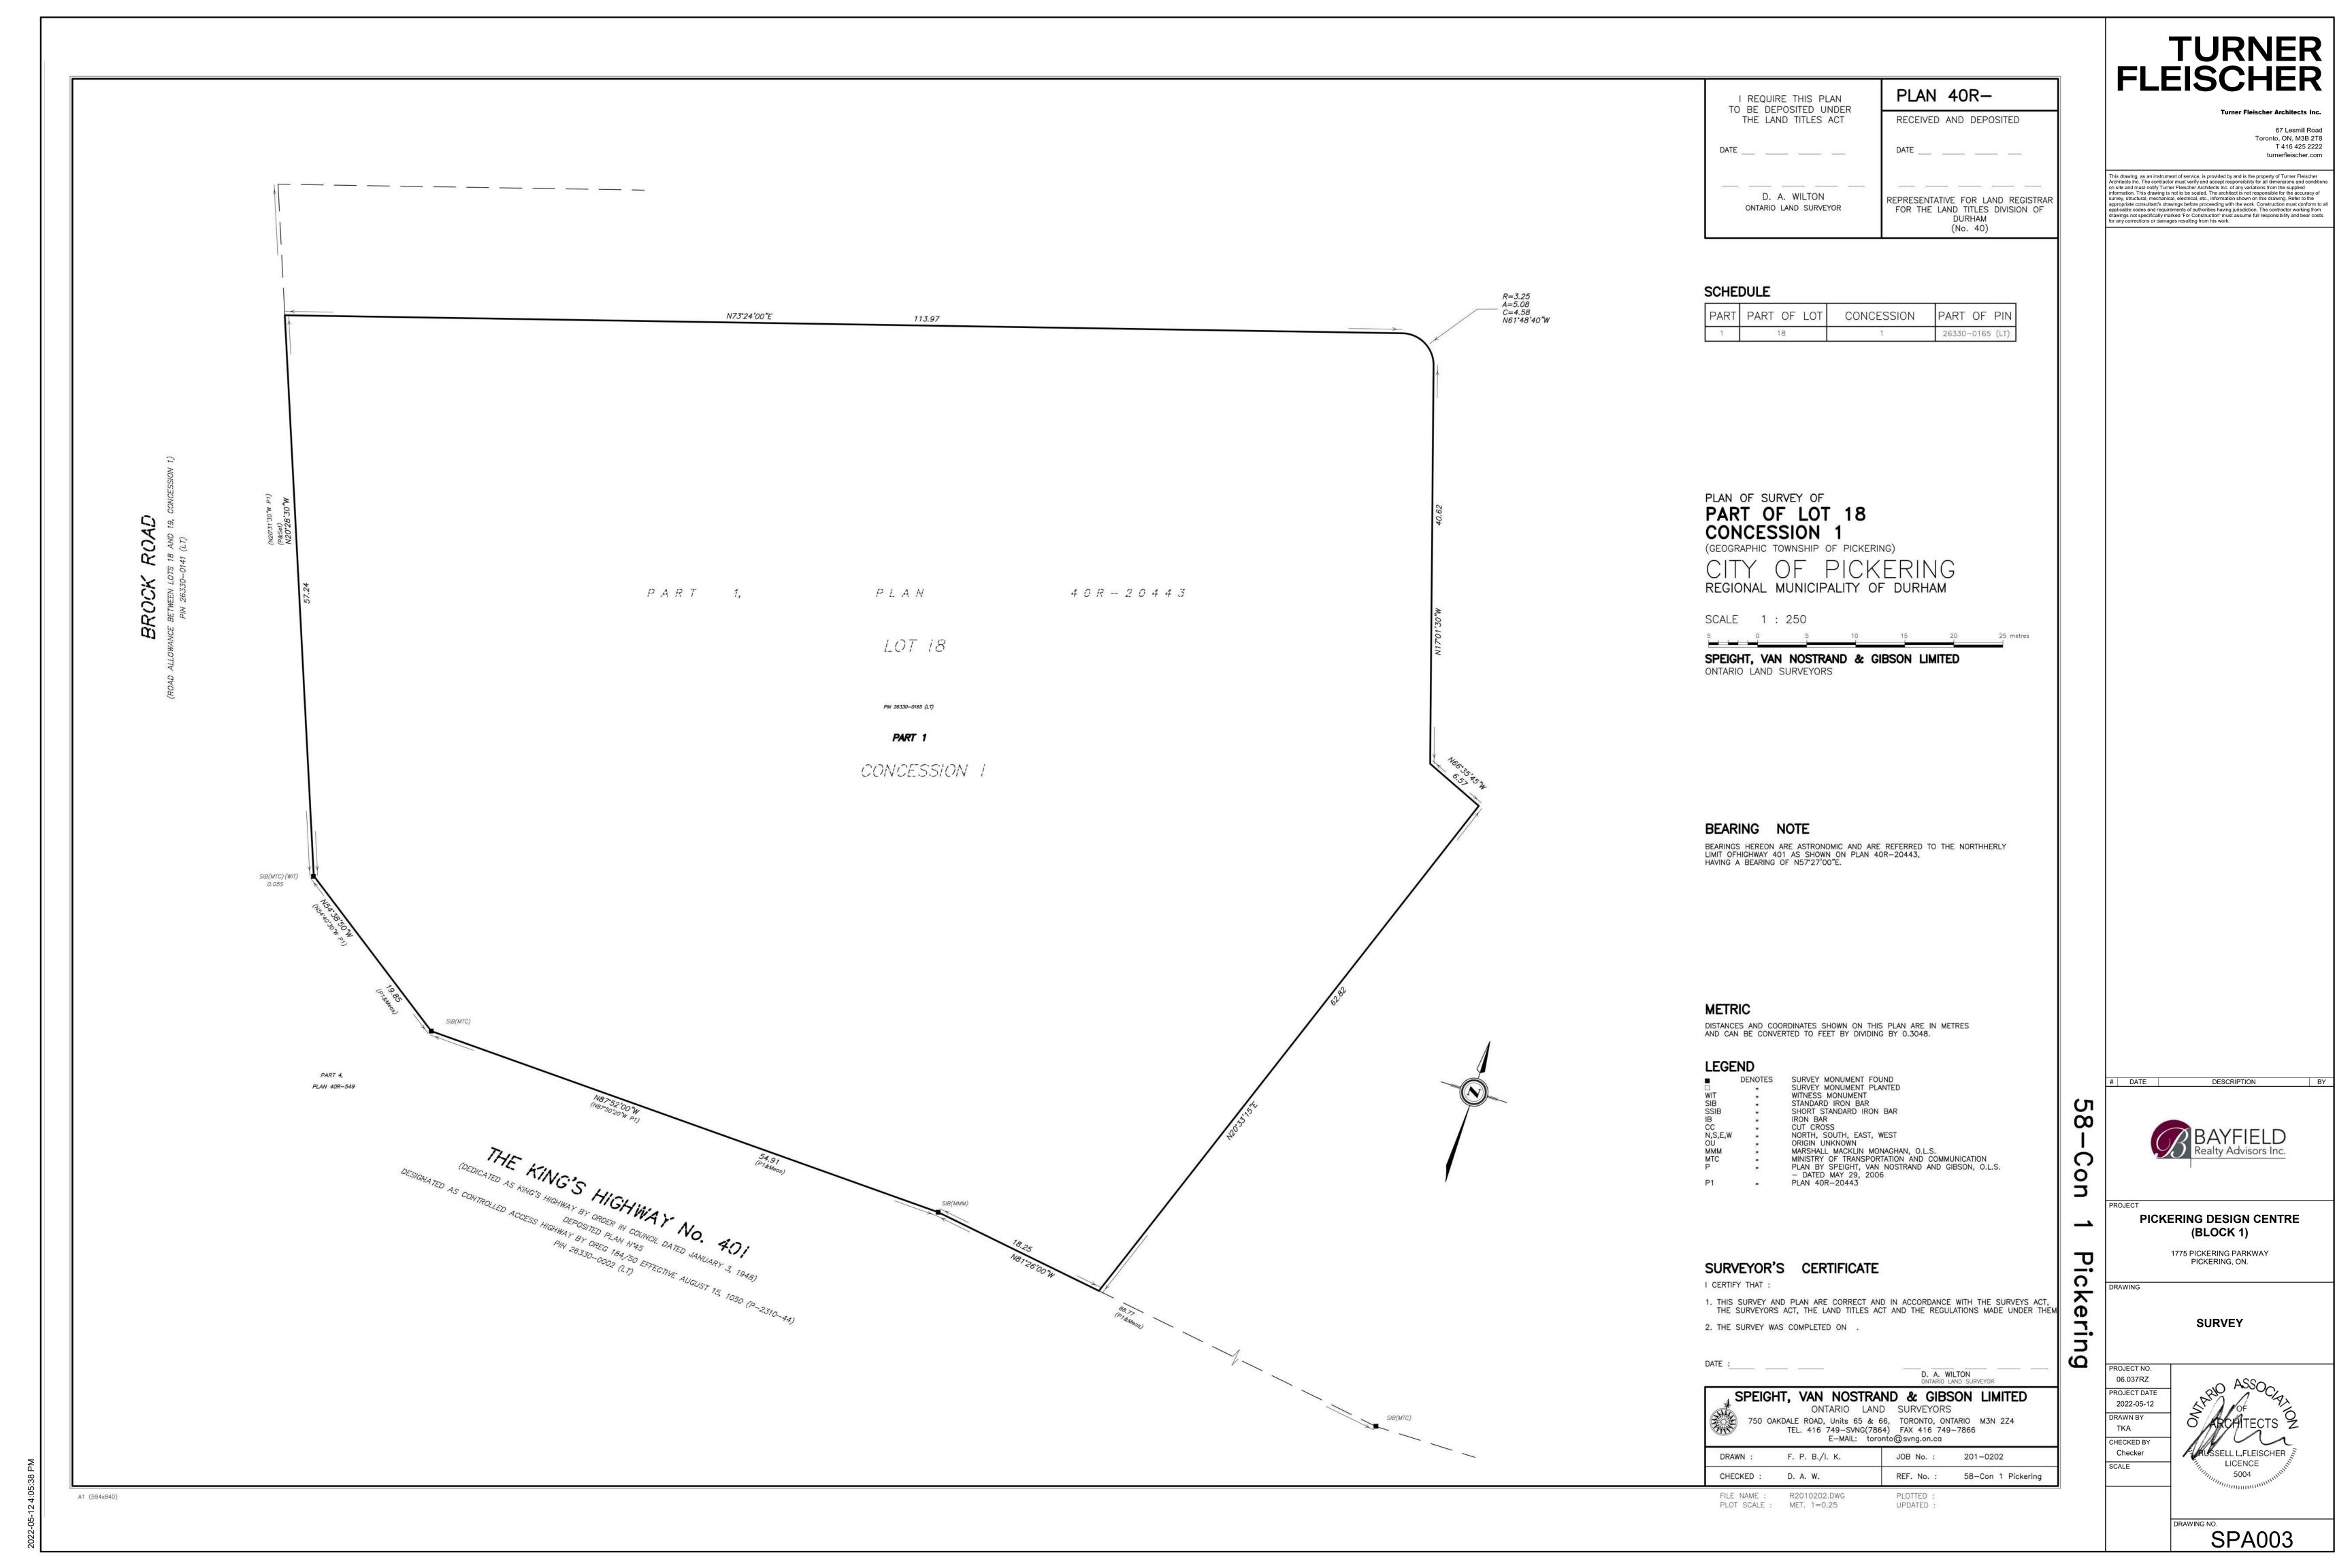



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DATE DESCRIPTION



PICKERING DESIGN CENTRE
(BLOCK 1)


1775 PICKERING PARKWAY PICKERING, ON.

DRAWING

CONTEXT PLAN

PROJECT NO.
06.037RZ
PROJECT DATE
2022-05-12
DRAWN BY
TKA
CHECKED BY
AYU
SCALE
1:1000



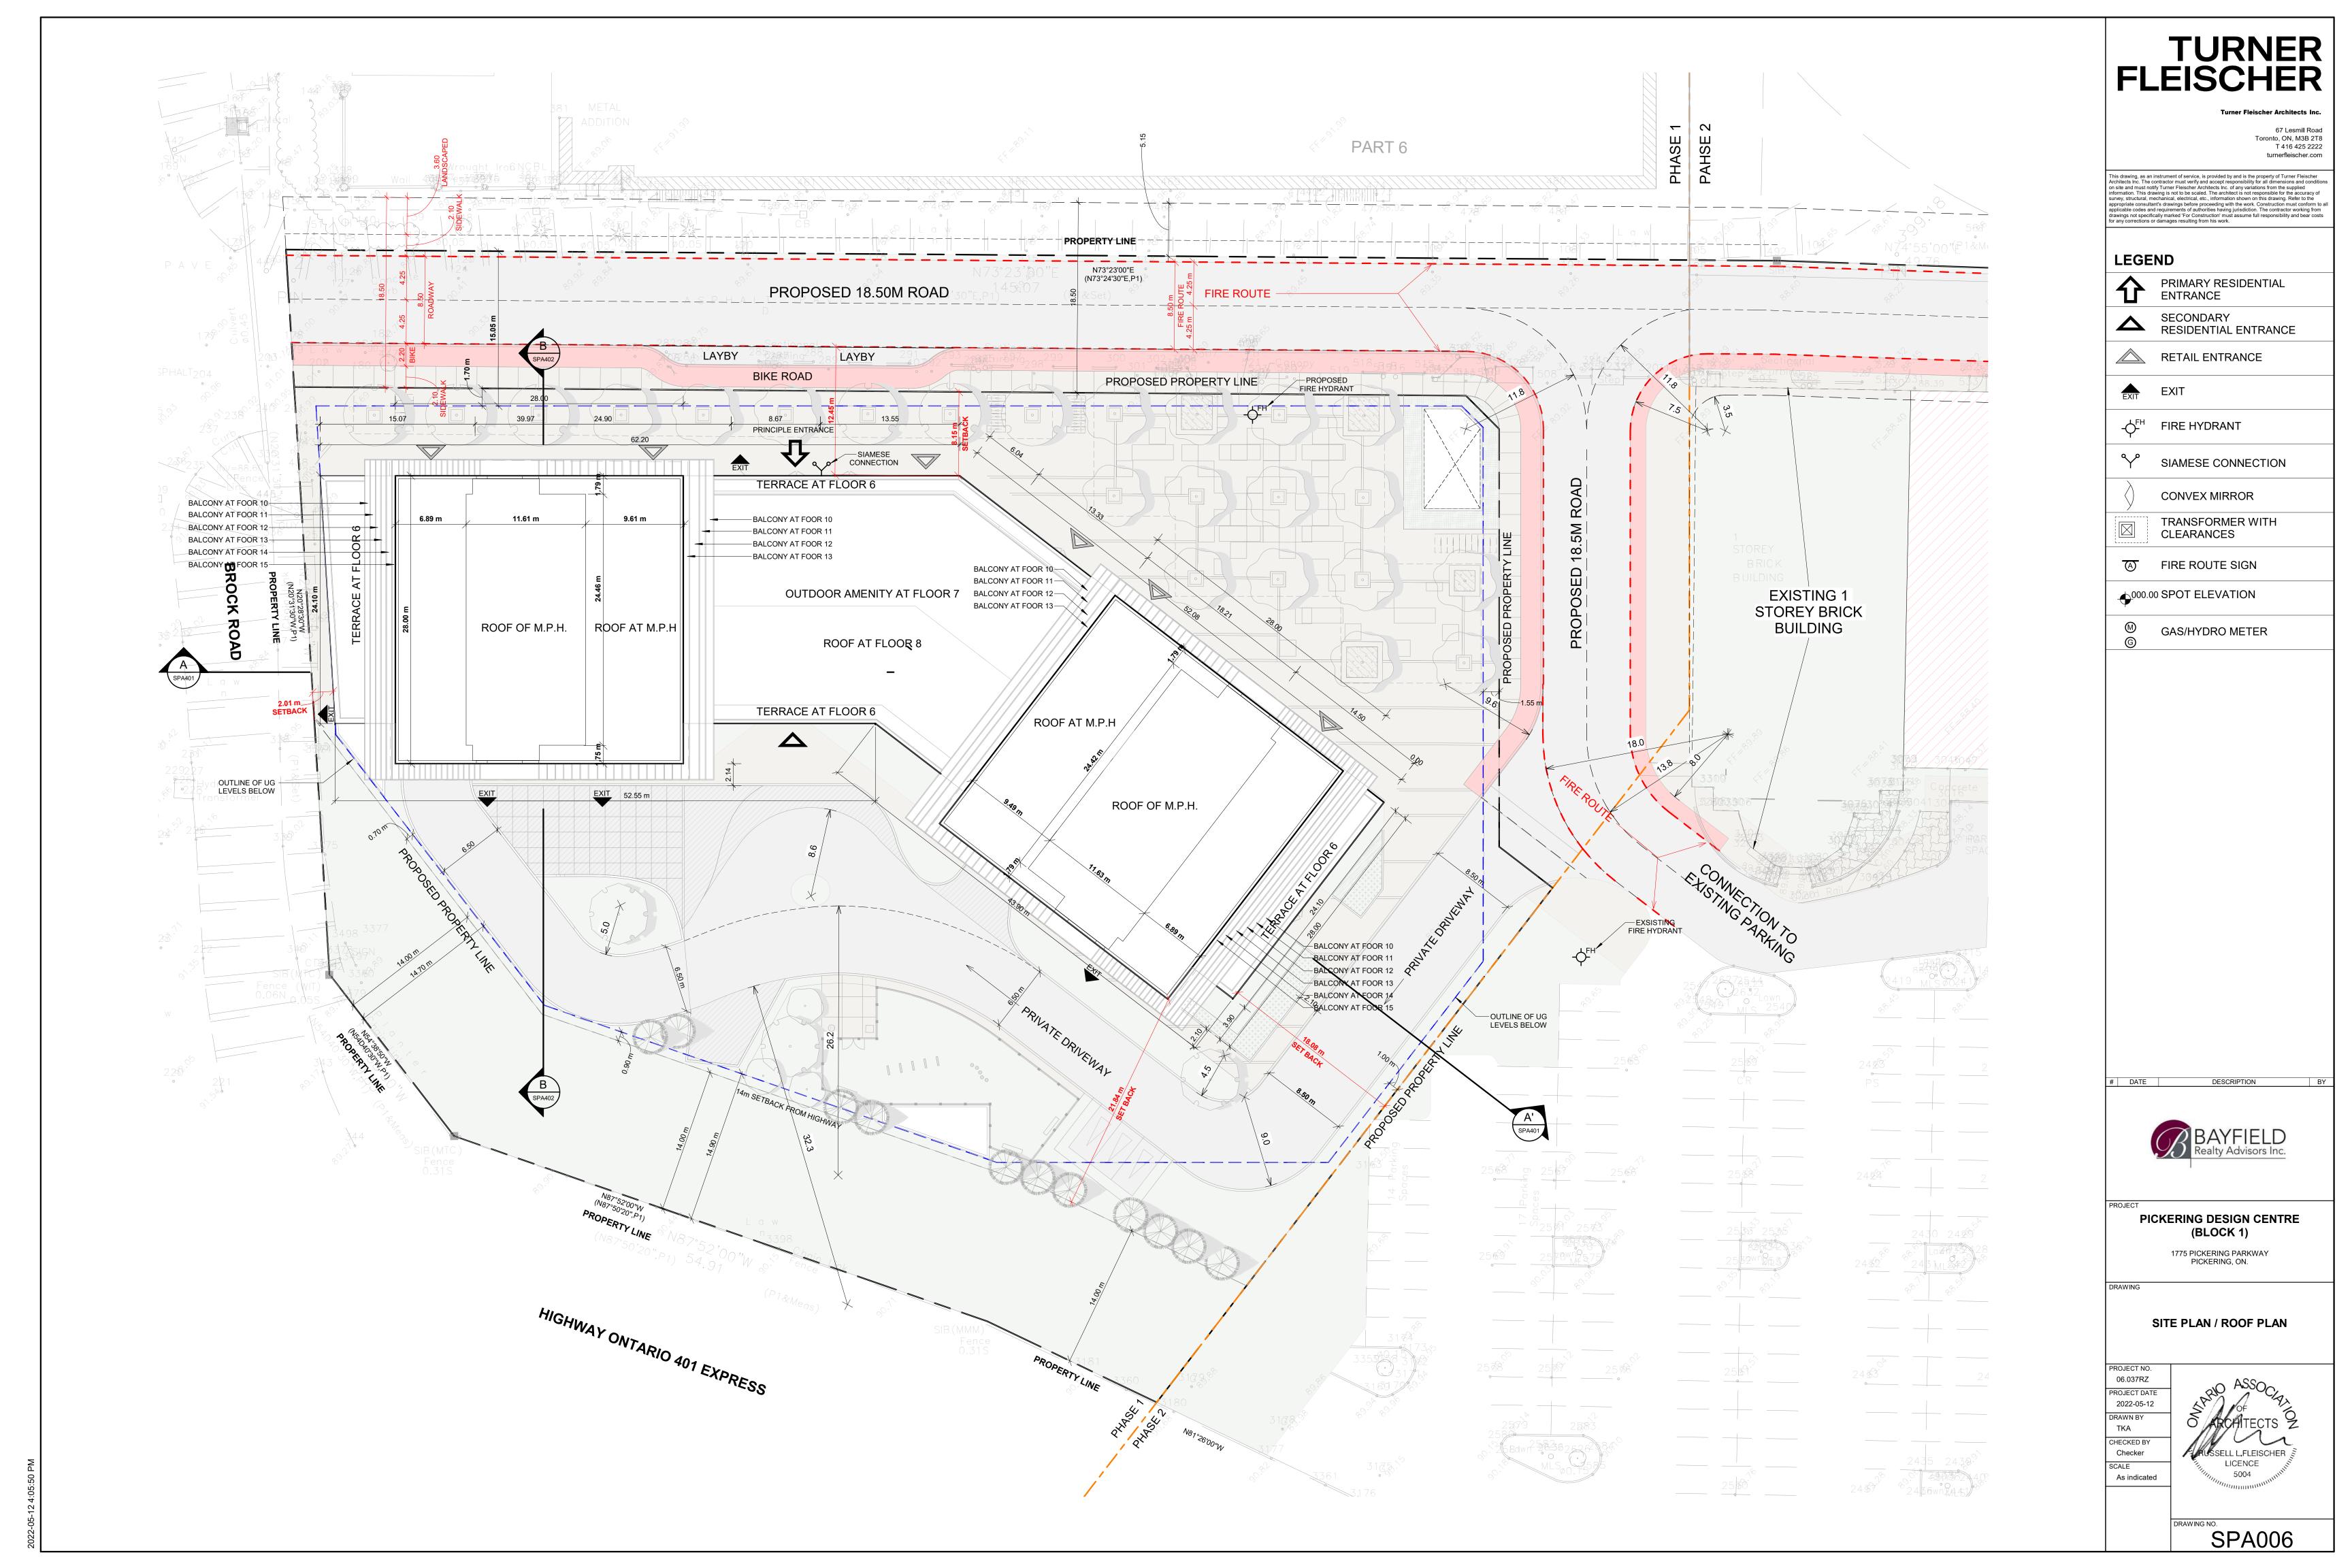

WASTE MANAGEMENT REQUIREMENTS - GENERAL NOTES

THE PROPOSED DEVELOPMENT WILL BE SERVED BY A GARAGE CHUTE WITHIN THE BUILDINGS WITH SEPERATE GARBAGE AND RECYCLING LOCATED ON THE GROUND FLOOR TO DIVERT GARBAGE AND RECYCLEABLE MATERIALS INTO SEPERATE BINS.

- PRIVATE COLLECTION WILL BE PROVIDED FOR COMMERCIAL WASTE MANAGEMENT
- MUNICIPAL COLLECTION WILL BE PROVIDED FOR THE RESIDENTIAL

 LINITS

THE PROPOSED WASTE COLLECTION AREAS WILL REQUIRE MOVEMENT OF BINS AND ROLL-AWAY CARTS BY PROPERTY MANAGEMENT DURING WASTE COLLECTION. AS SUCH:

- PROPERTY MANAGEMENT IS RESPONSIBLE FOR MOVING BINS DURING COLLECTION TO STAGING AREA
- GARBAGE TO BE TRACTORED FROM GARBAGE ROOMS TO STAGING AREA

SOLID WASTE MANAGEMNET REQUIREMENTS (CITY OF PICKERING)

- A FRONT END GARBAGE BIN WITH A CAPACITY OF ONE CUBIC YARD PER TEN (10) RESIDENTIAL UNITS
- ROLLOUT RECYLCING CART, ONE 95 GALLON CART FOR EVERY 7 UNITS

TOWER A1

TOWER A2

<u>GARBAGE</u>

346 UNITS/40 (NUMBER OF UNITS PER

BIN) = 9 BINS (4 CUBIC YARDS)

RECYCLING

346 UNITS/7 (NUMBER OF UNITS PER CART)= 49 BINS (95 GALLON)

GARBAGE

332 UNITS/40 (NUMBER OF UNITS PER BIN) = 8 BINS (4 CUBIC YARDS)


RECYCLING

332 UNITS/7 (NUMBER OF UNITS PER CART)= 47 BINS (95 GALLON)

TOTAL NUMBER OF UNITS = 678

TOTAL NUMBER OF GARBAGE BINS = 17 (4 CUBIC YARD BINS)

TOTAL NUMBER OF RECYCLING BINS = 96 (96 GALLON CARTS)

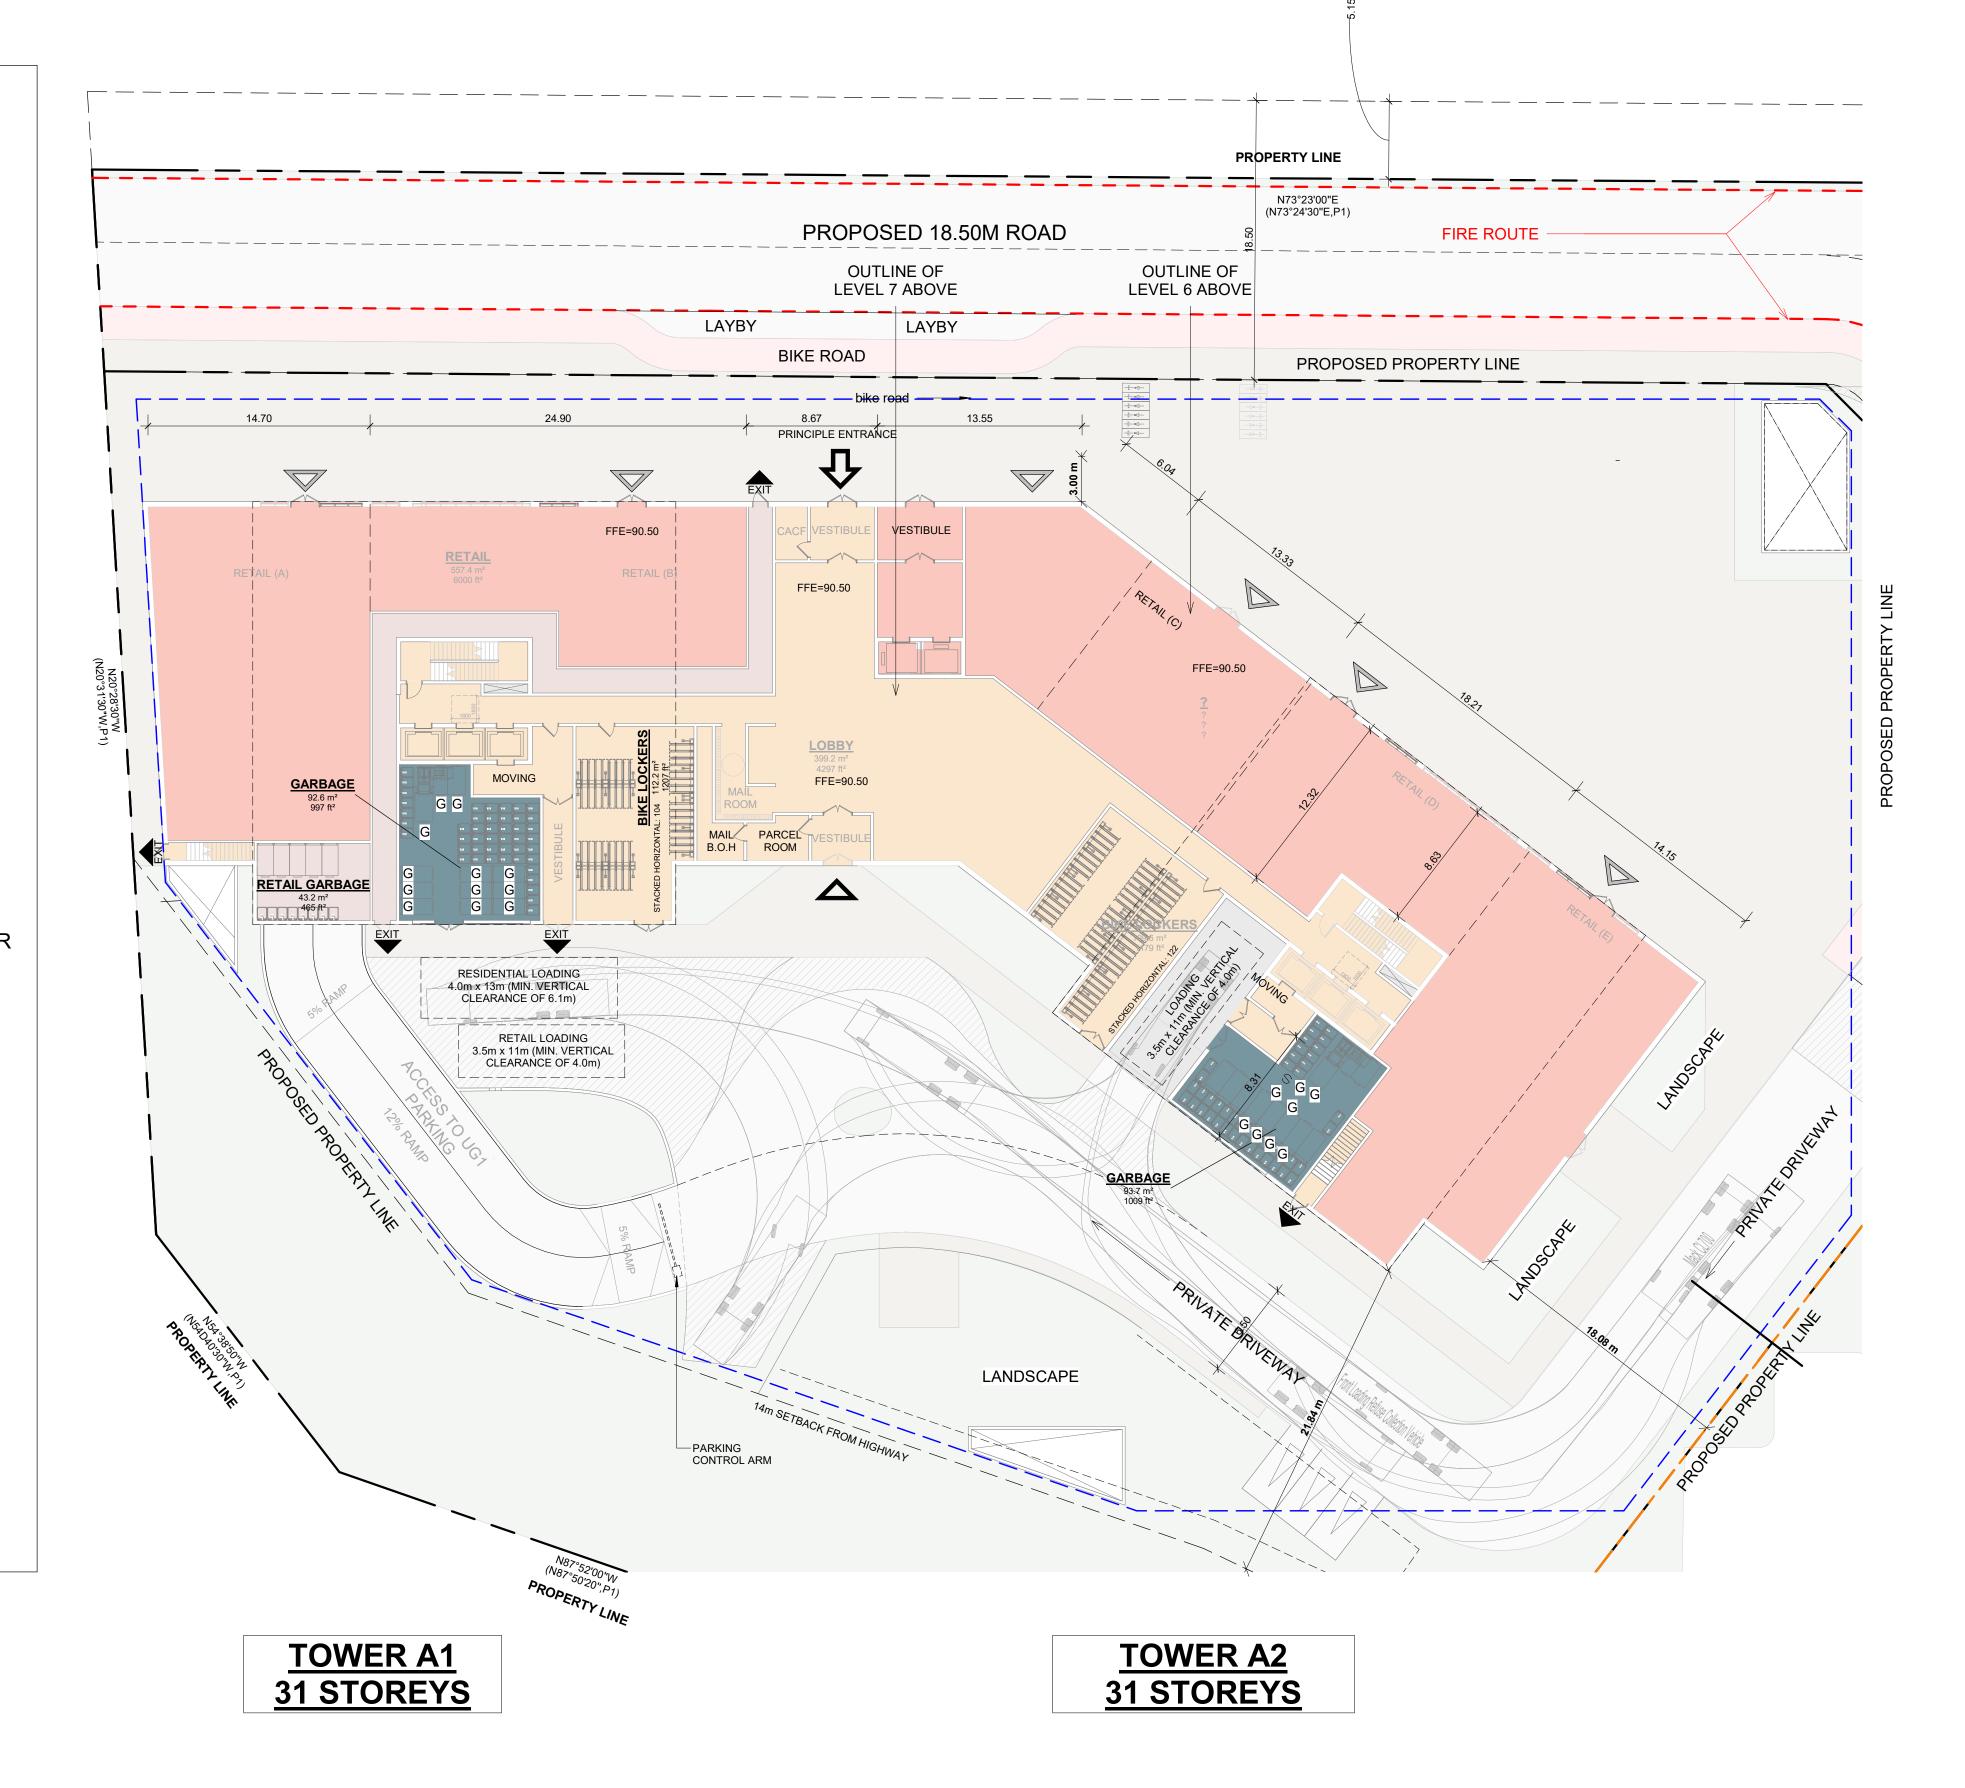

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PICKERING DESIGN CENTRE (BLOCK 1)

> 1775 PICKERING PARKWAY PICKERING, ON.

RESIDENTIAL SOLID WASTE MANAGEMENT

PROJECT NO.
06.037RZ

PROJECT DATE
2022-05-12

DRAWN BY
TKA

CHECKED BY

AYU

ADSOCIATION OF OF ARCHITECTS

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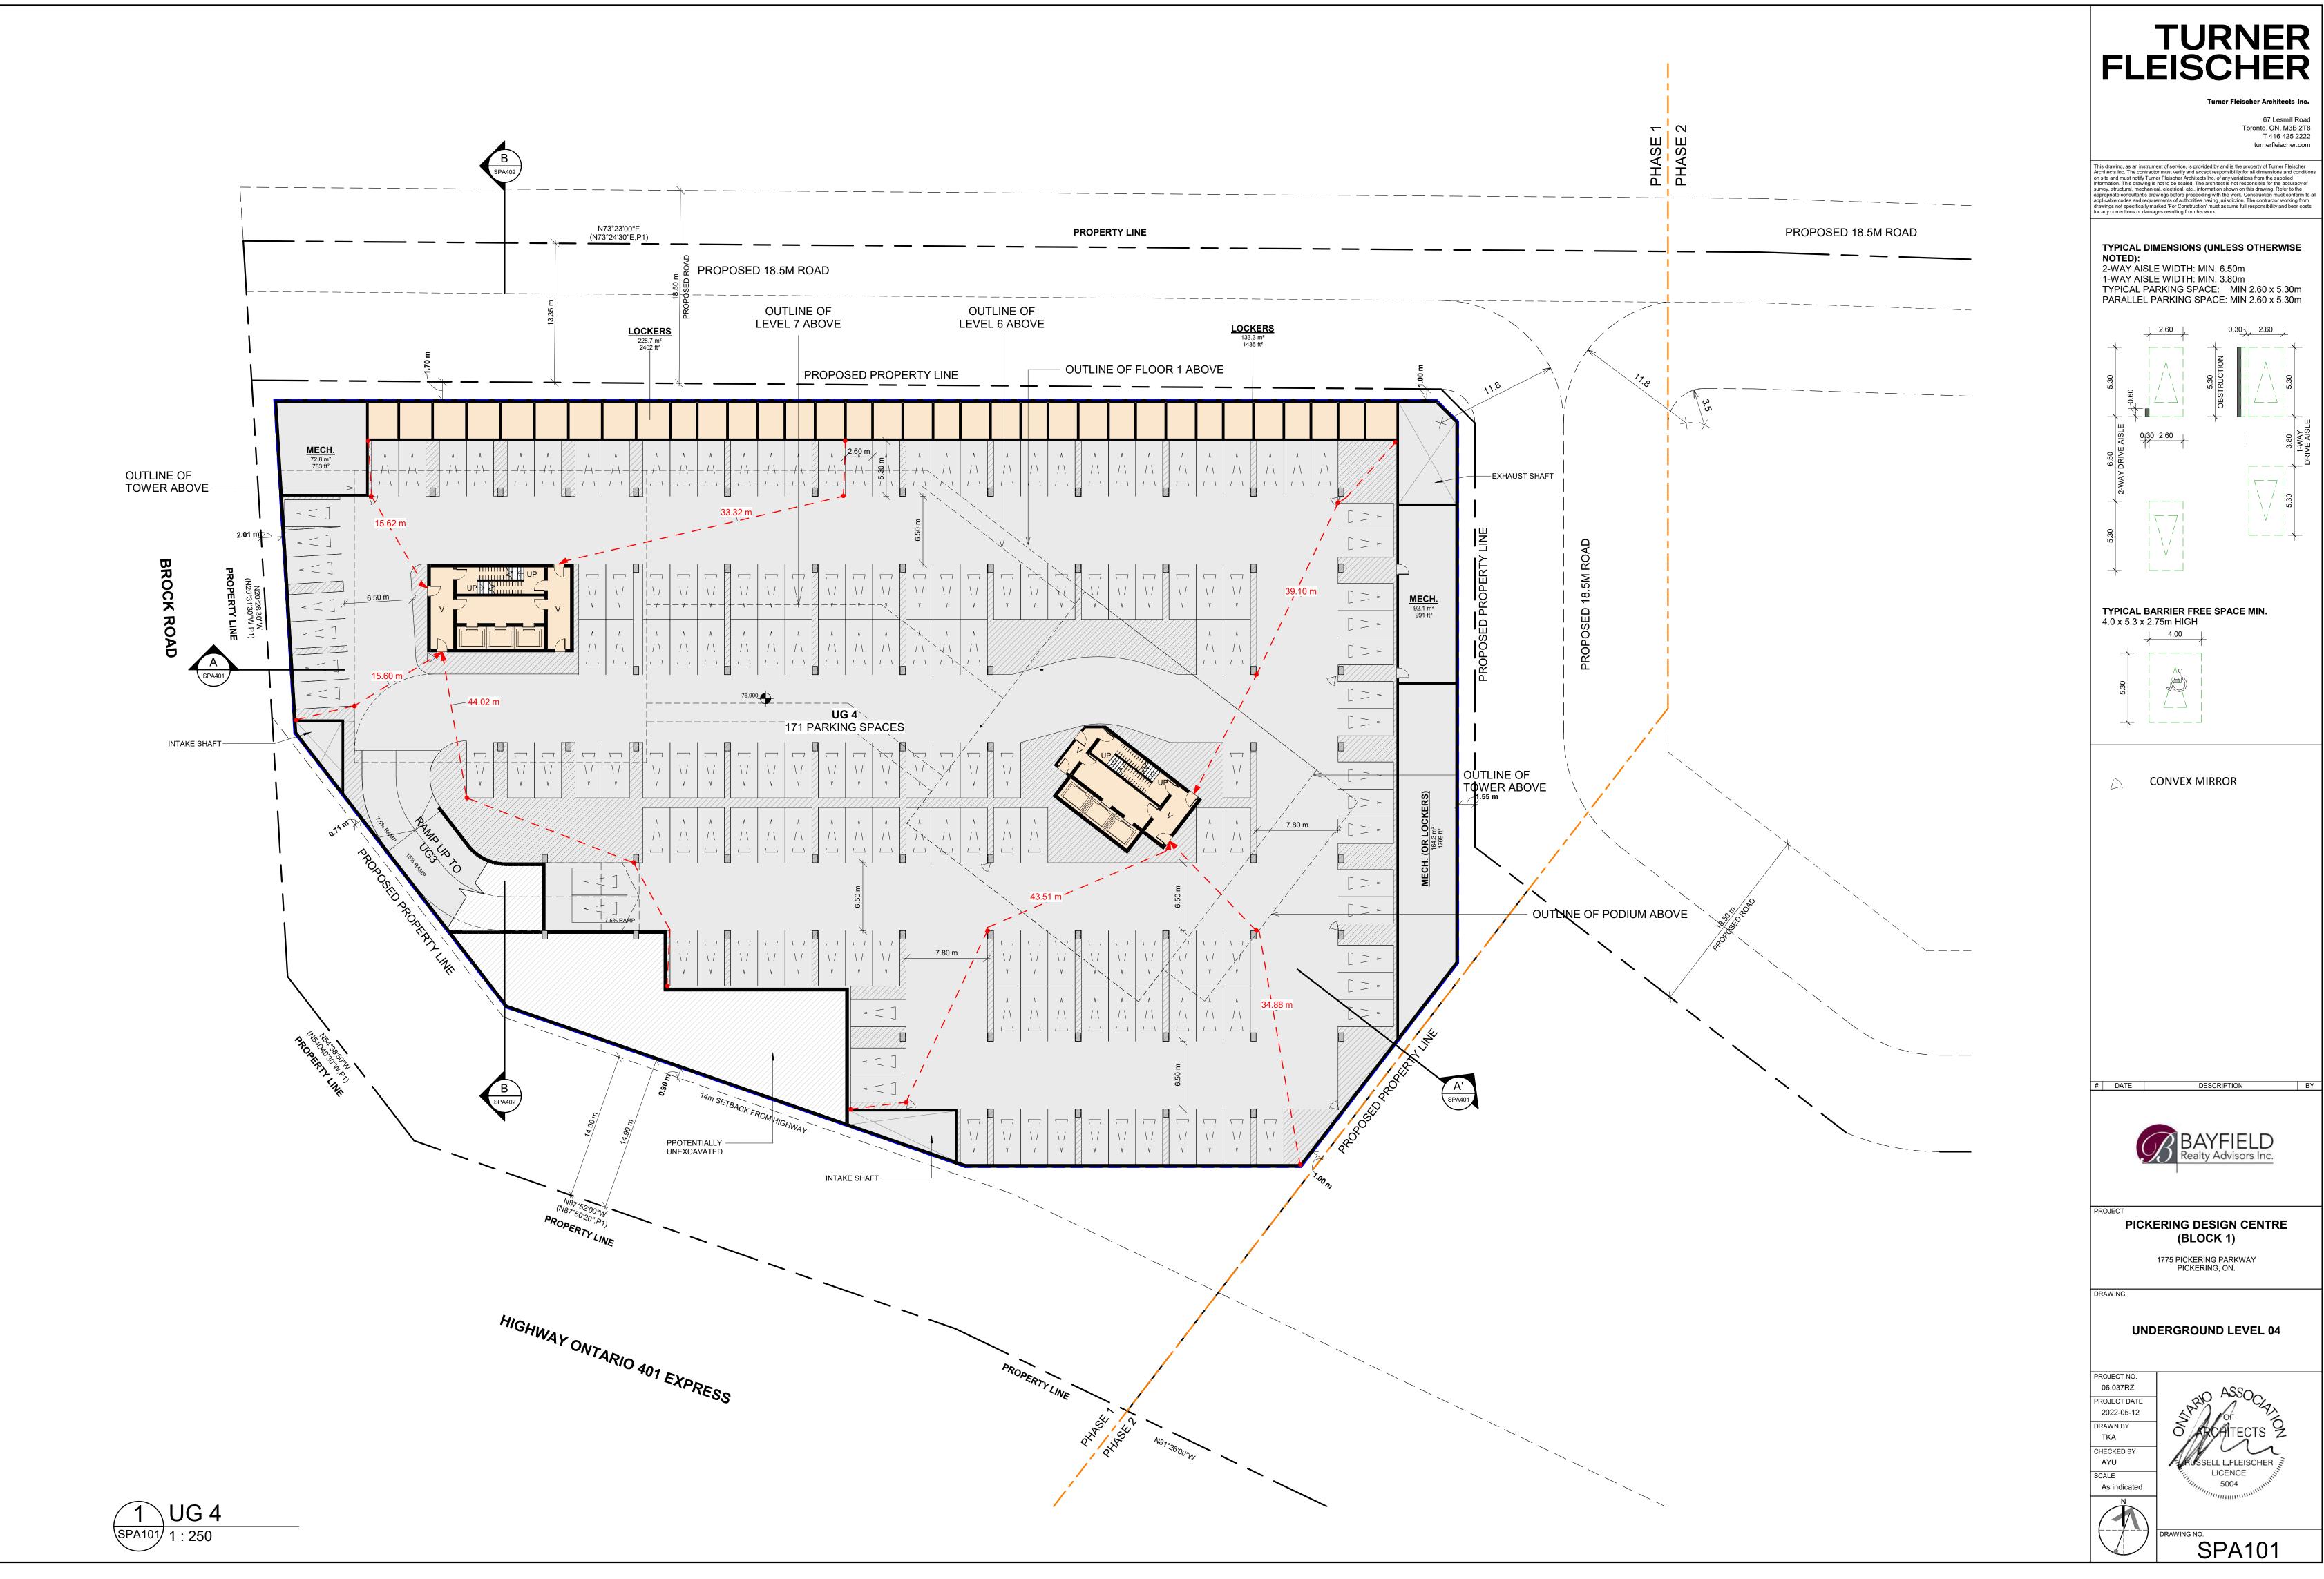
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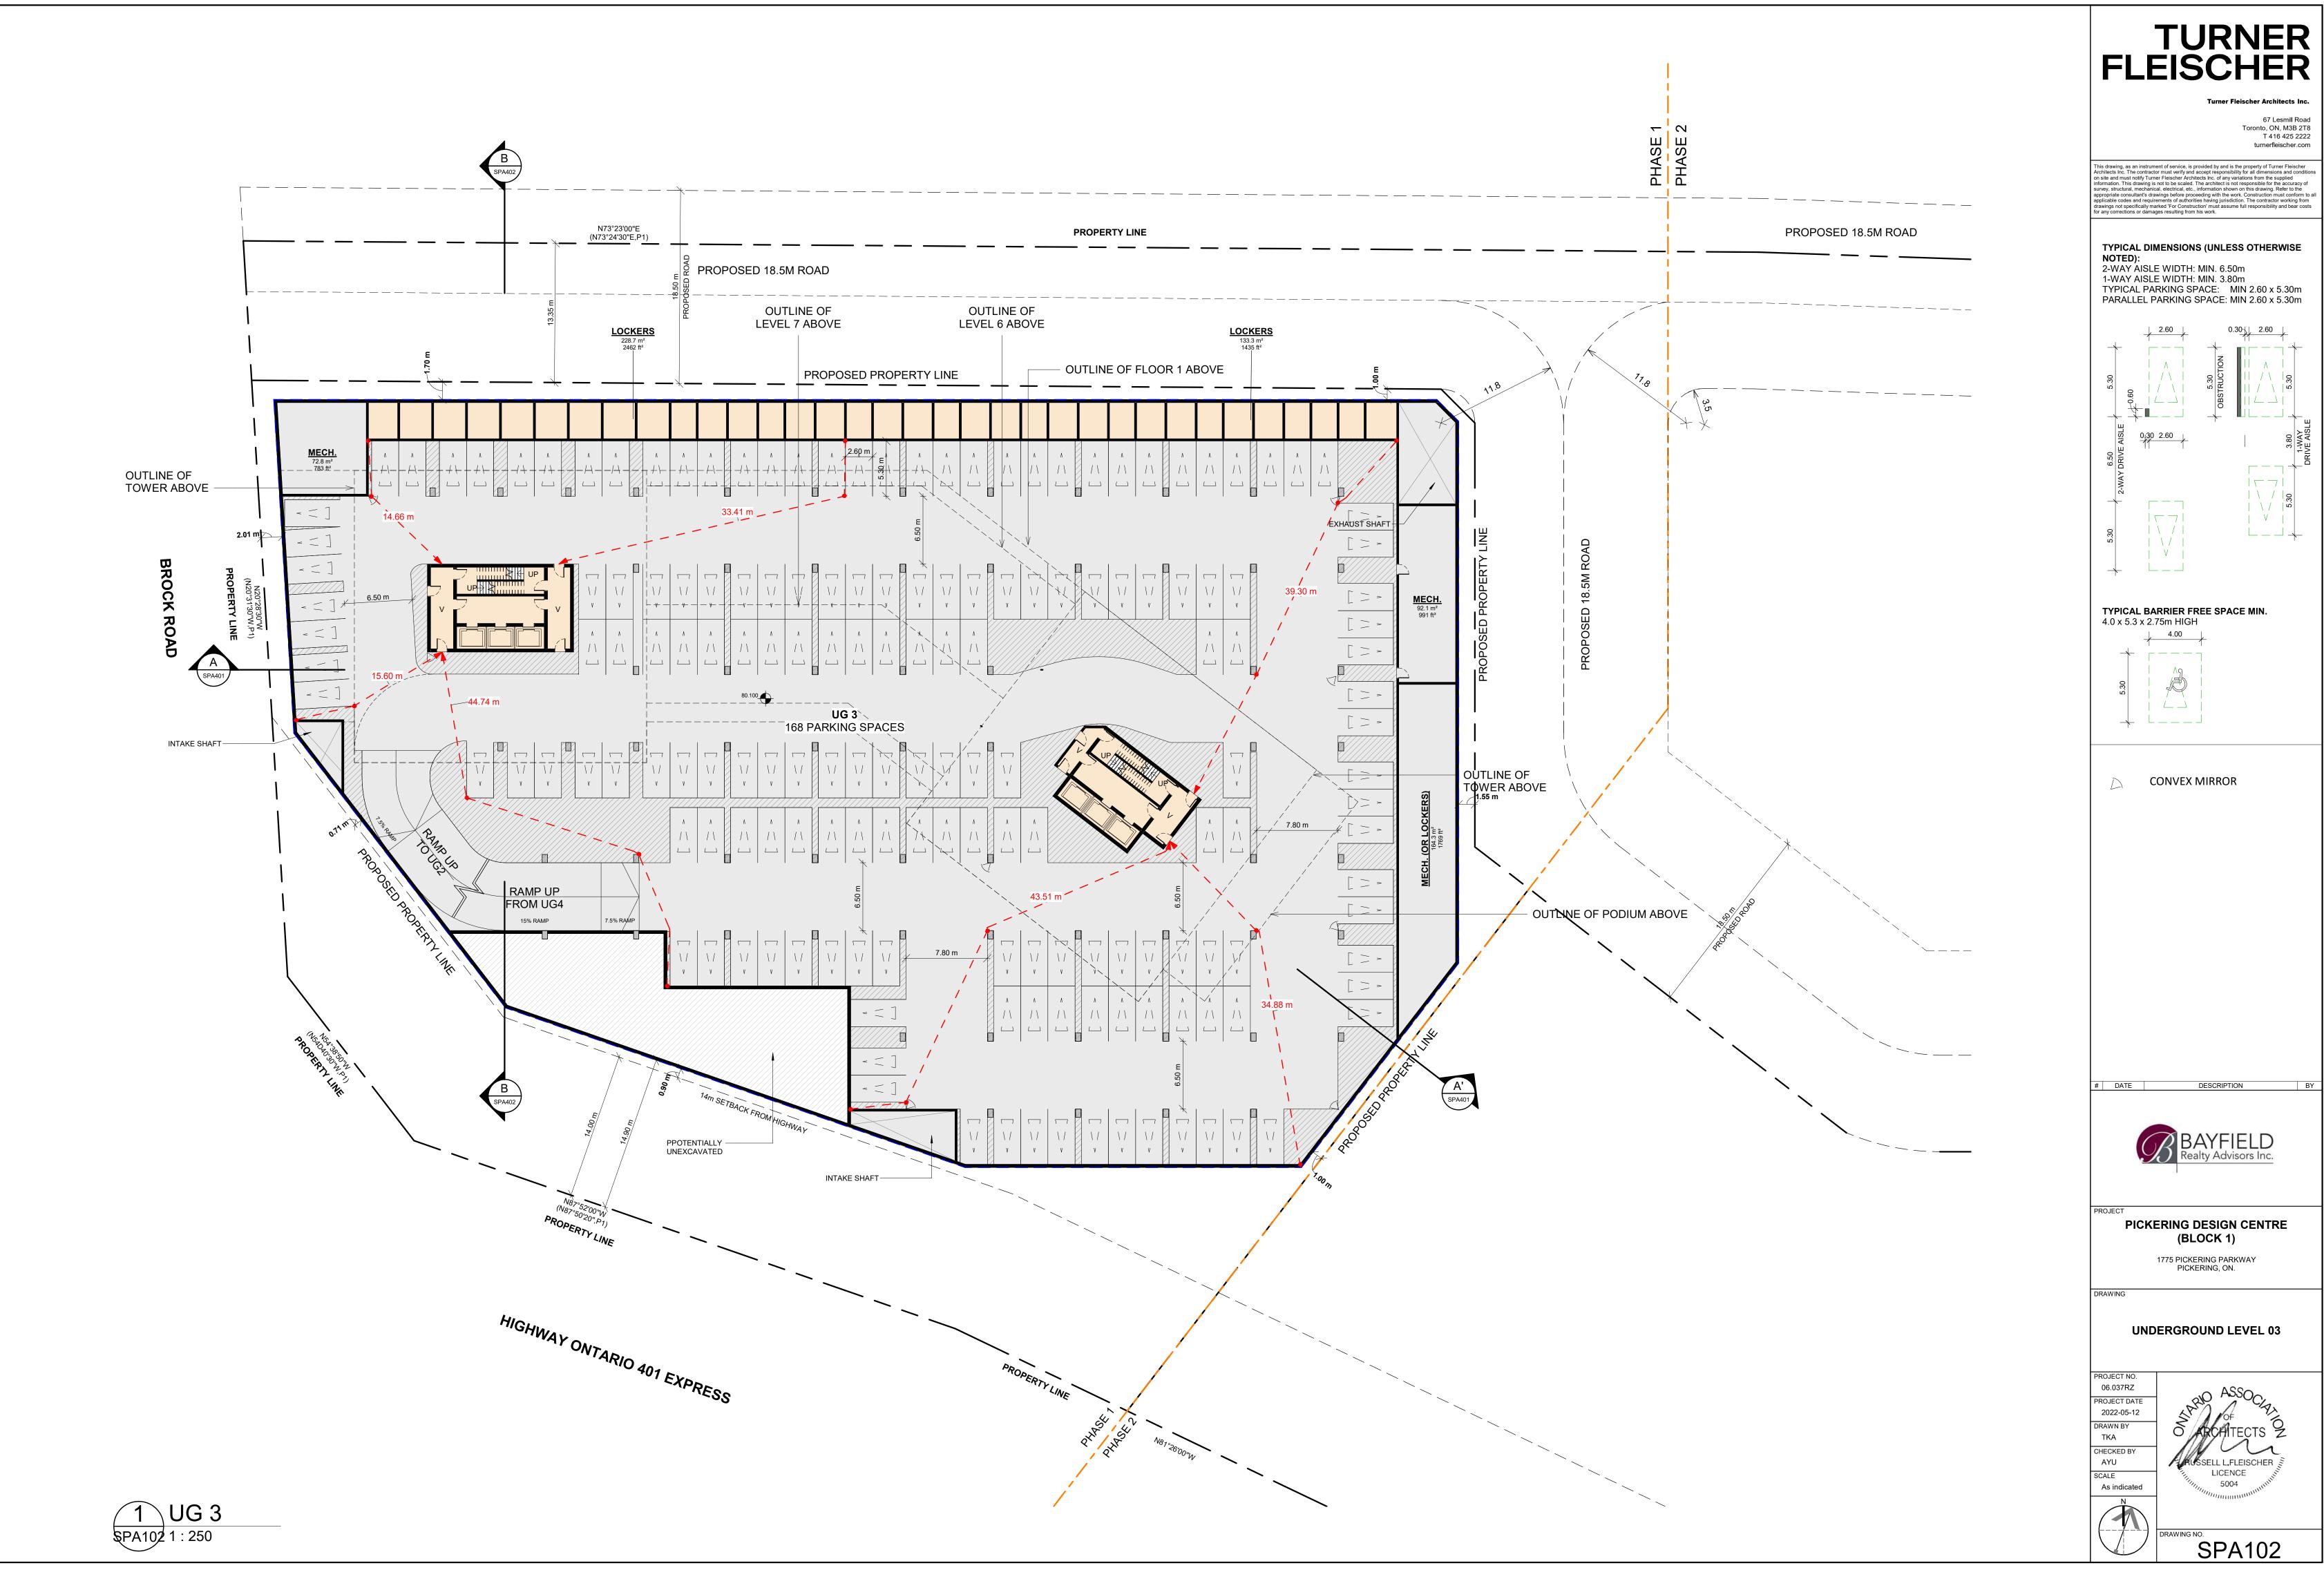
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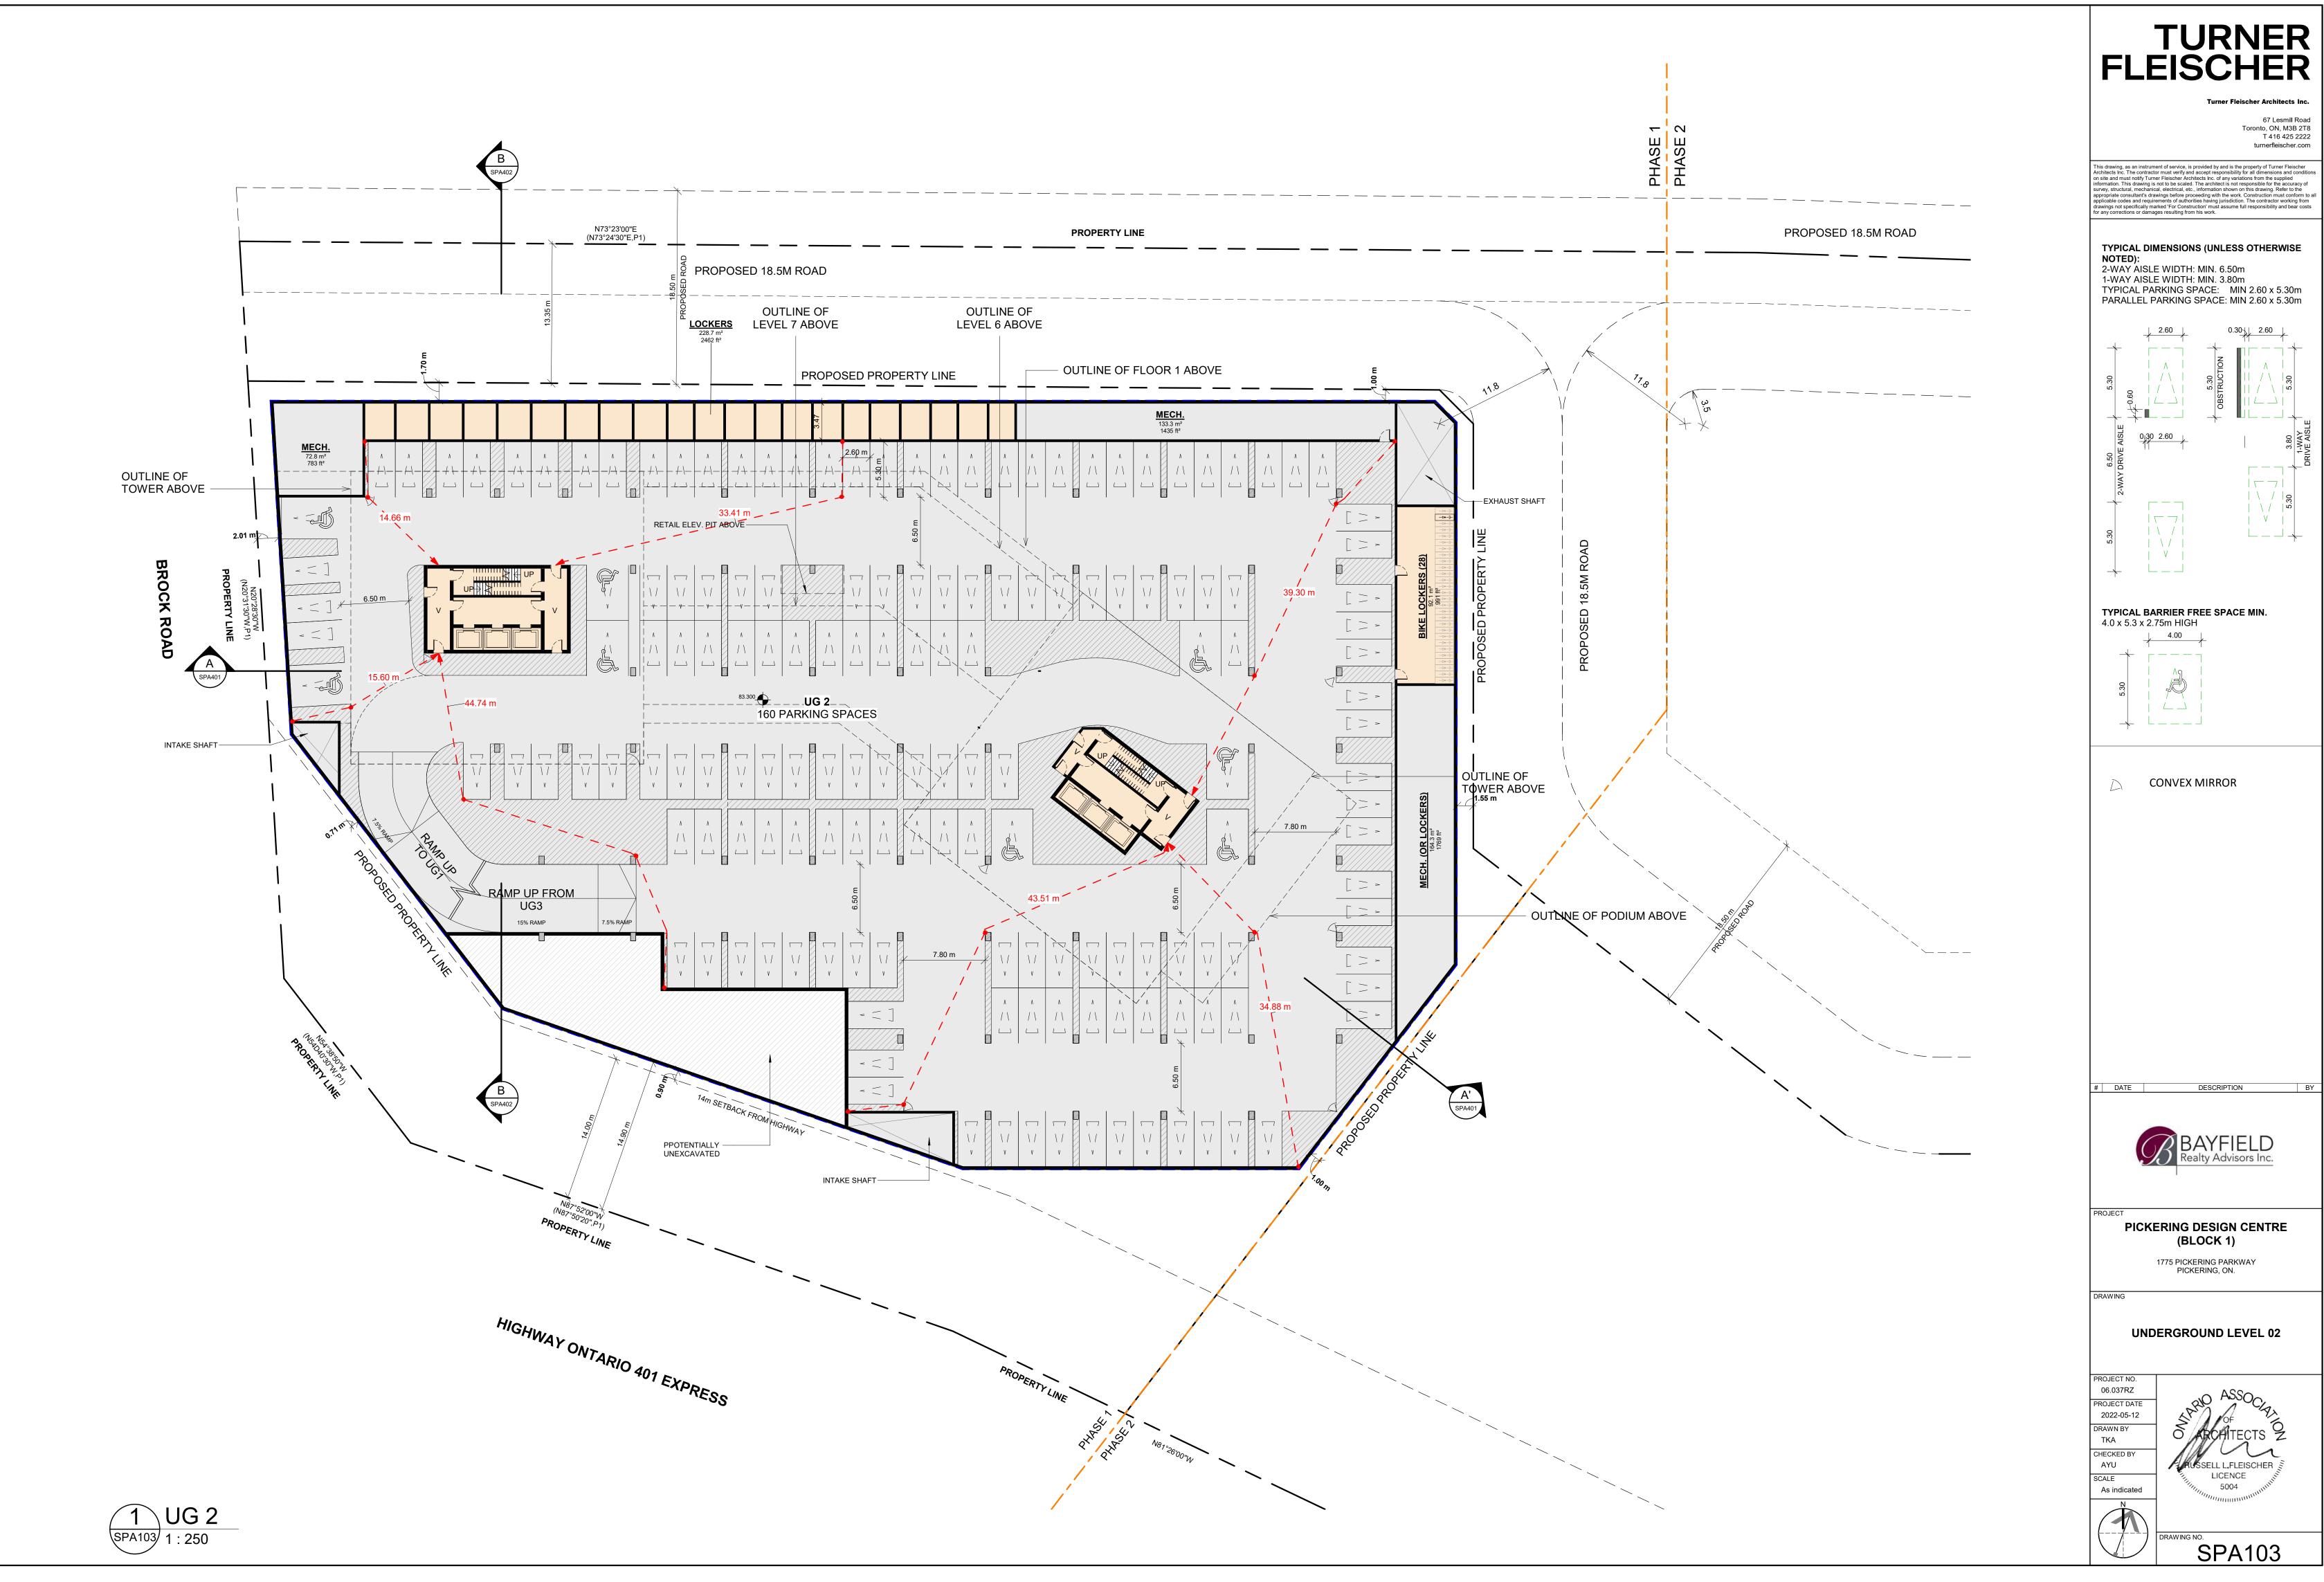
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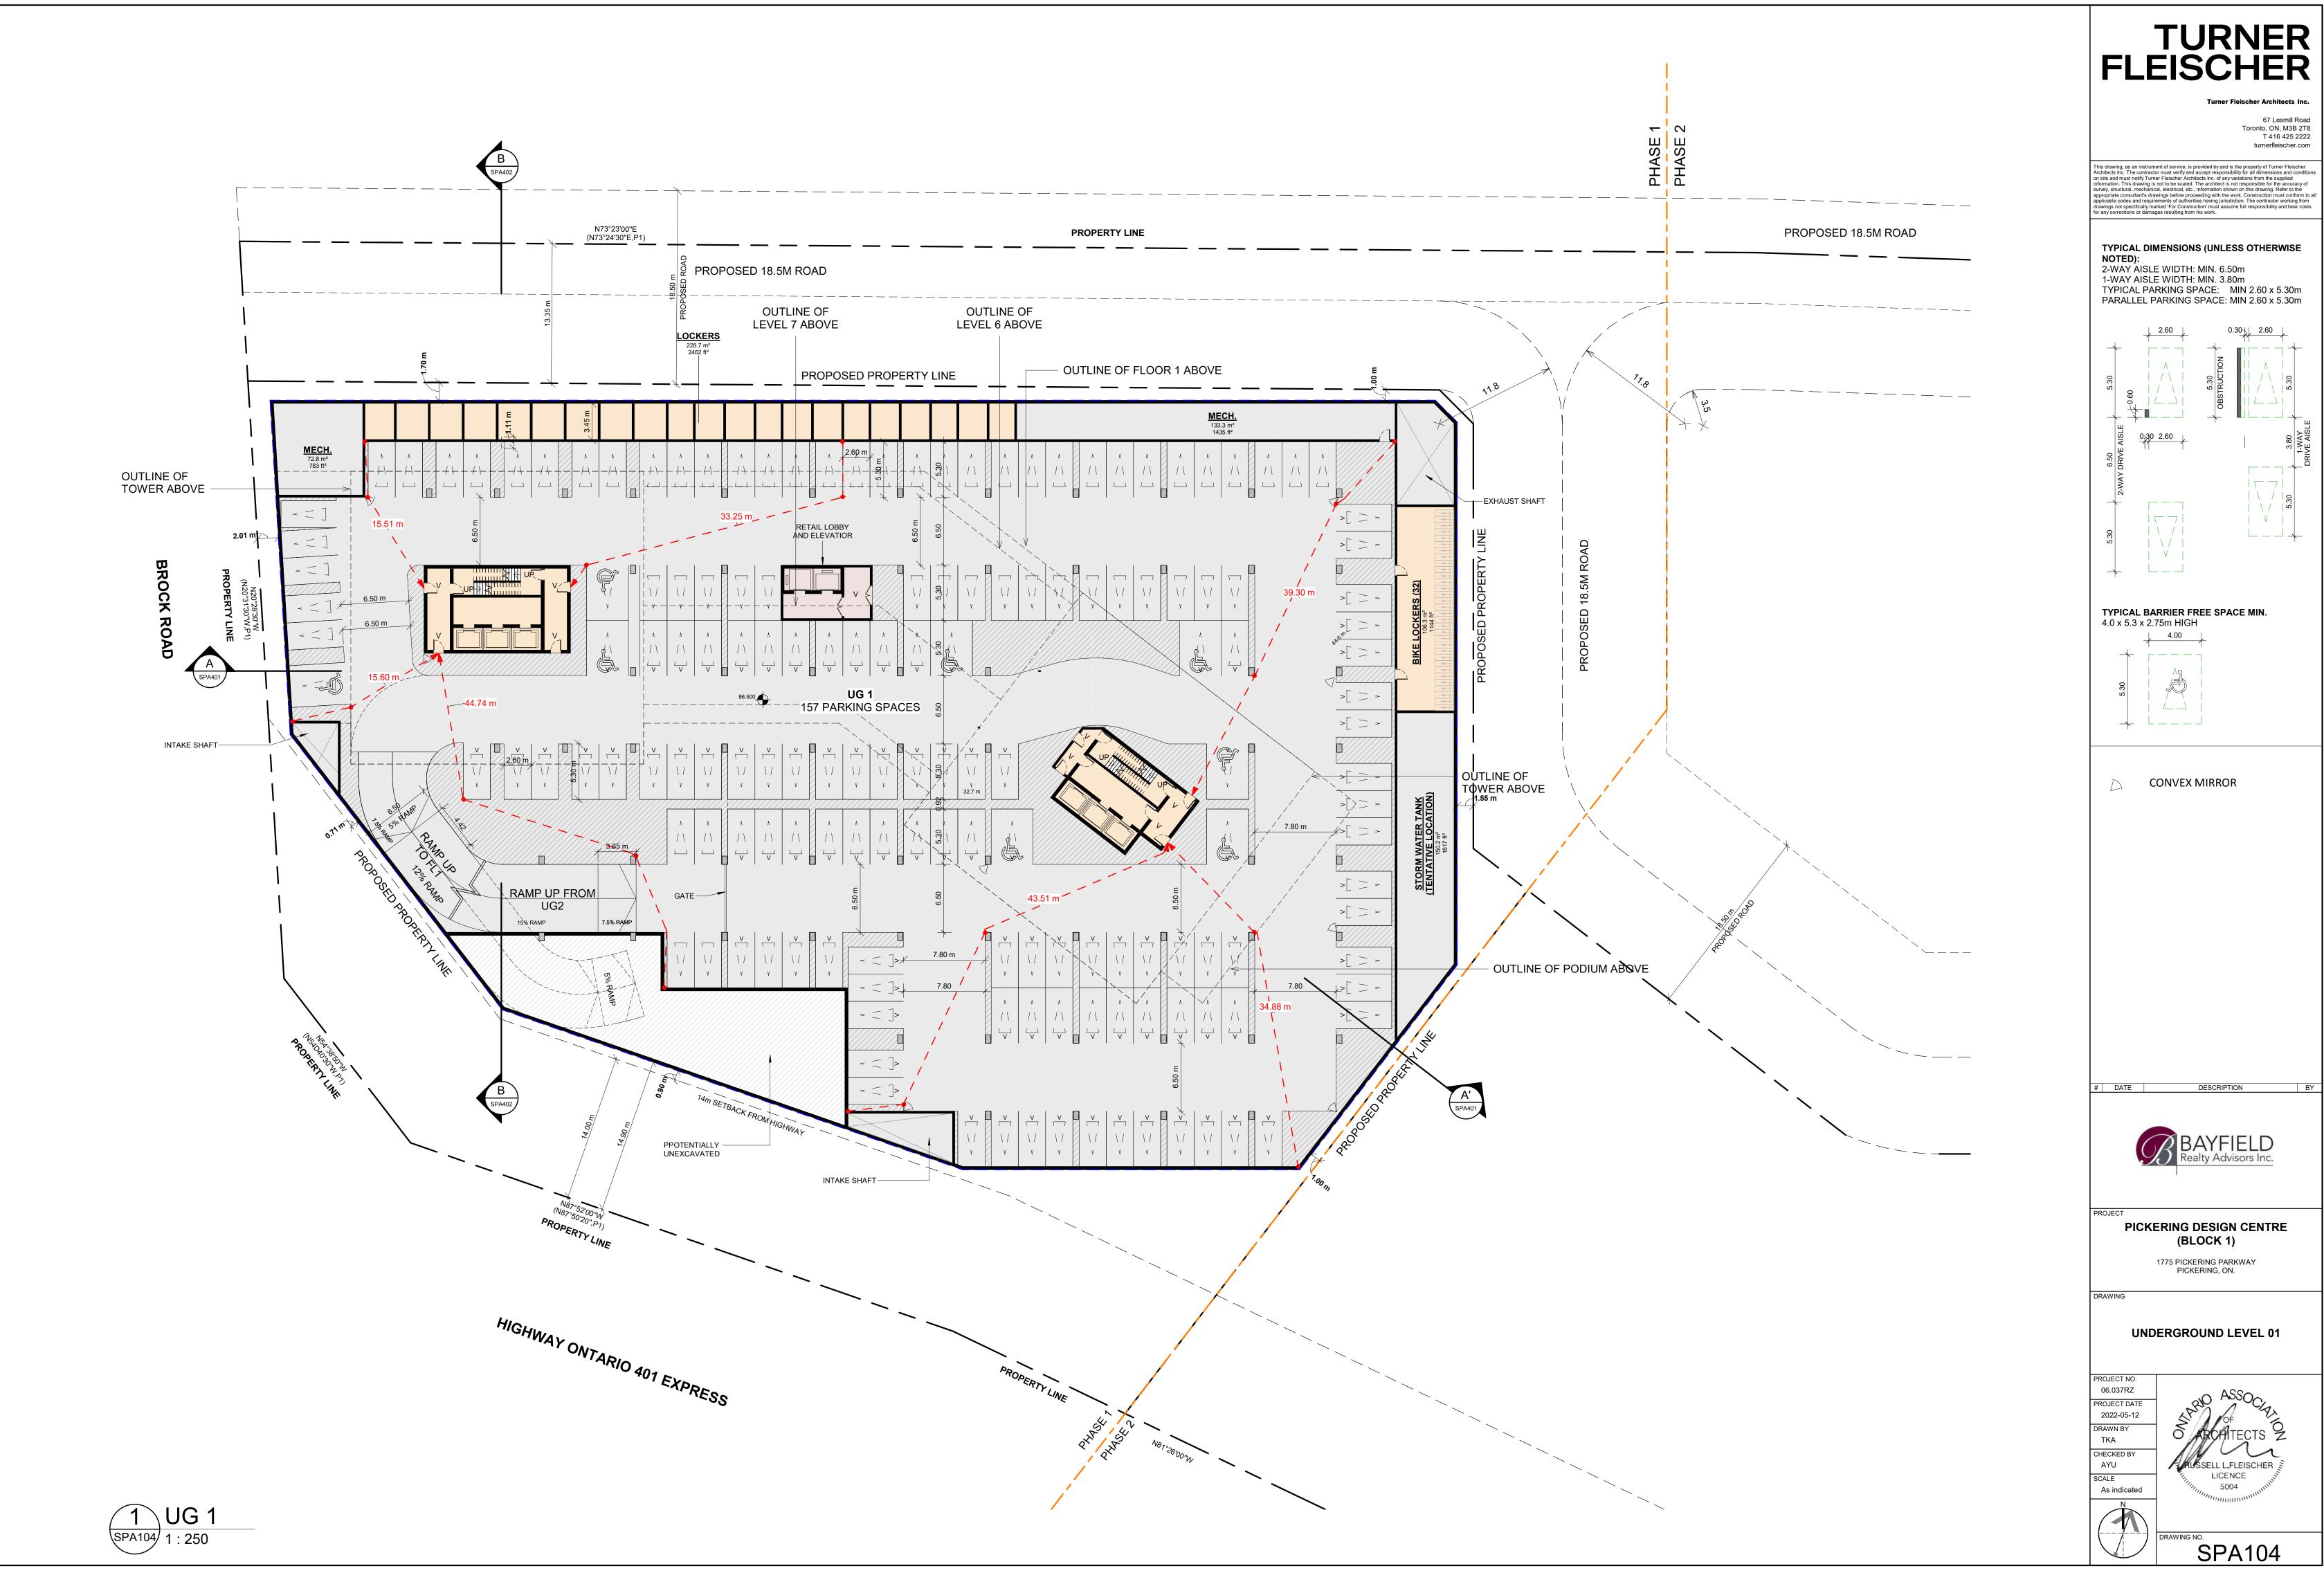
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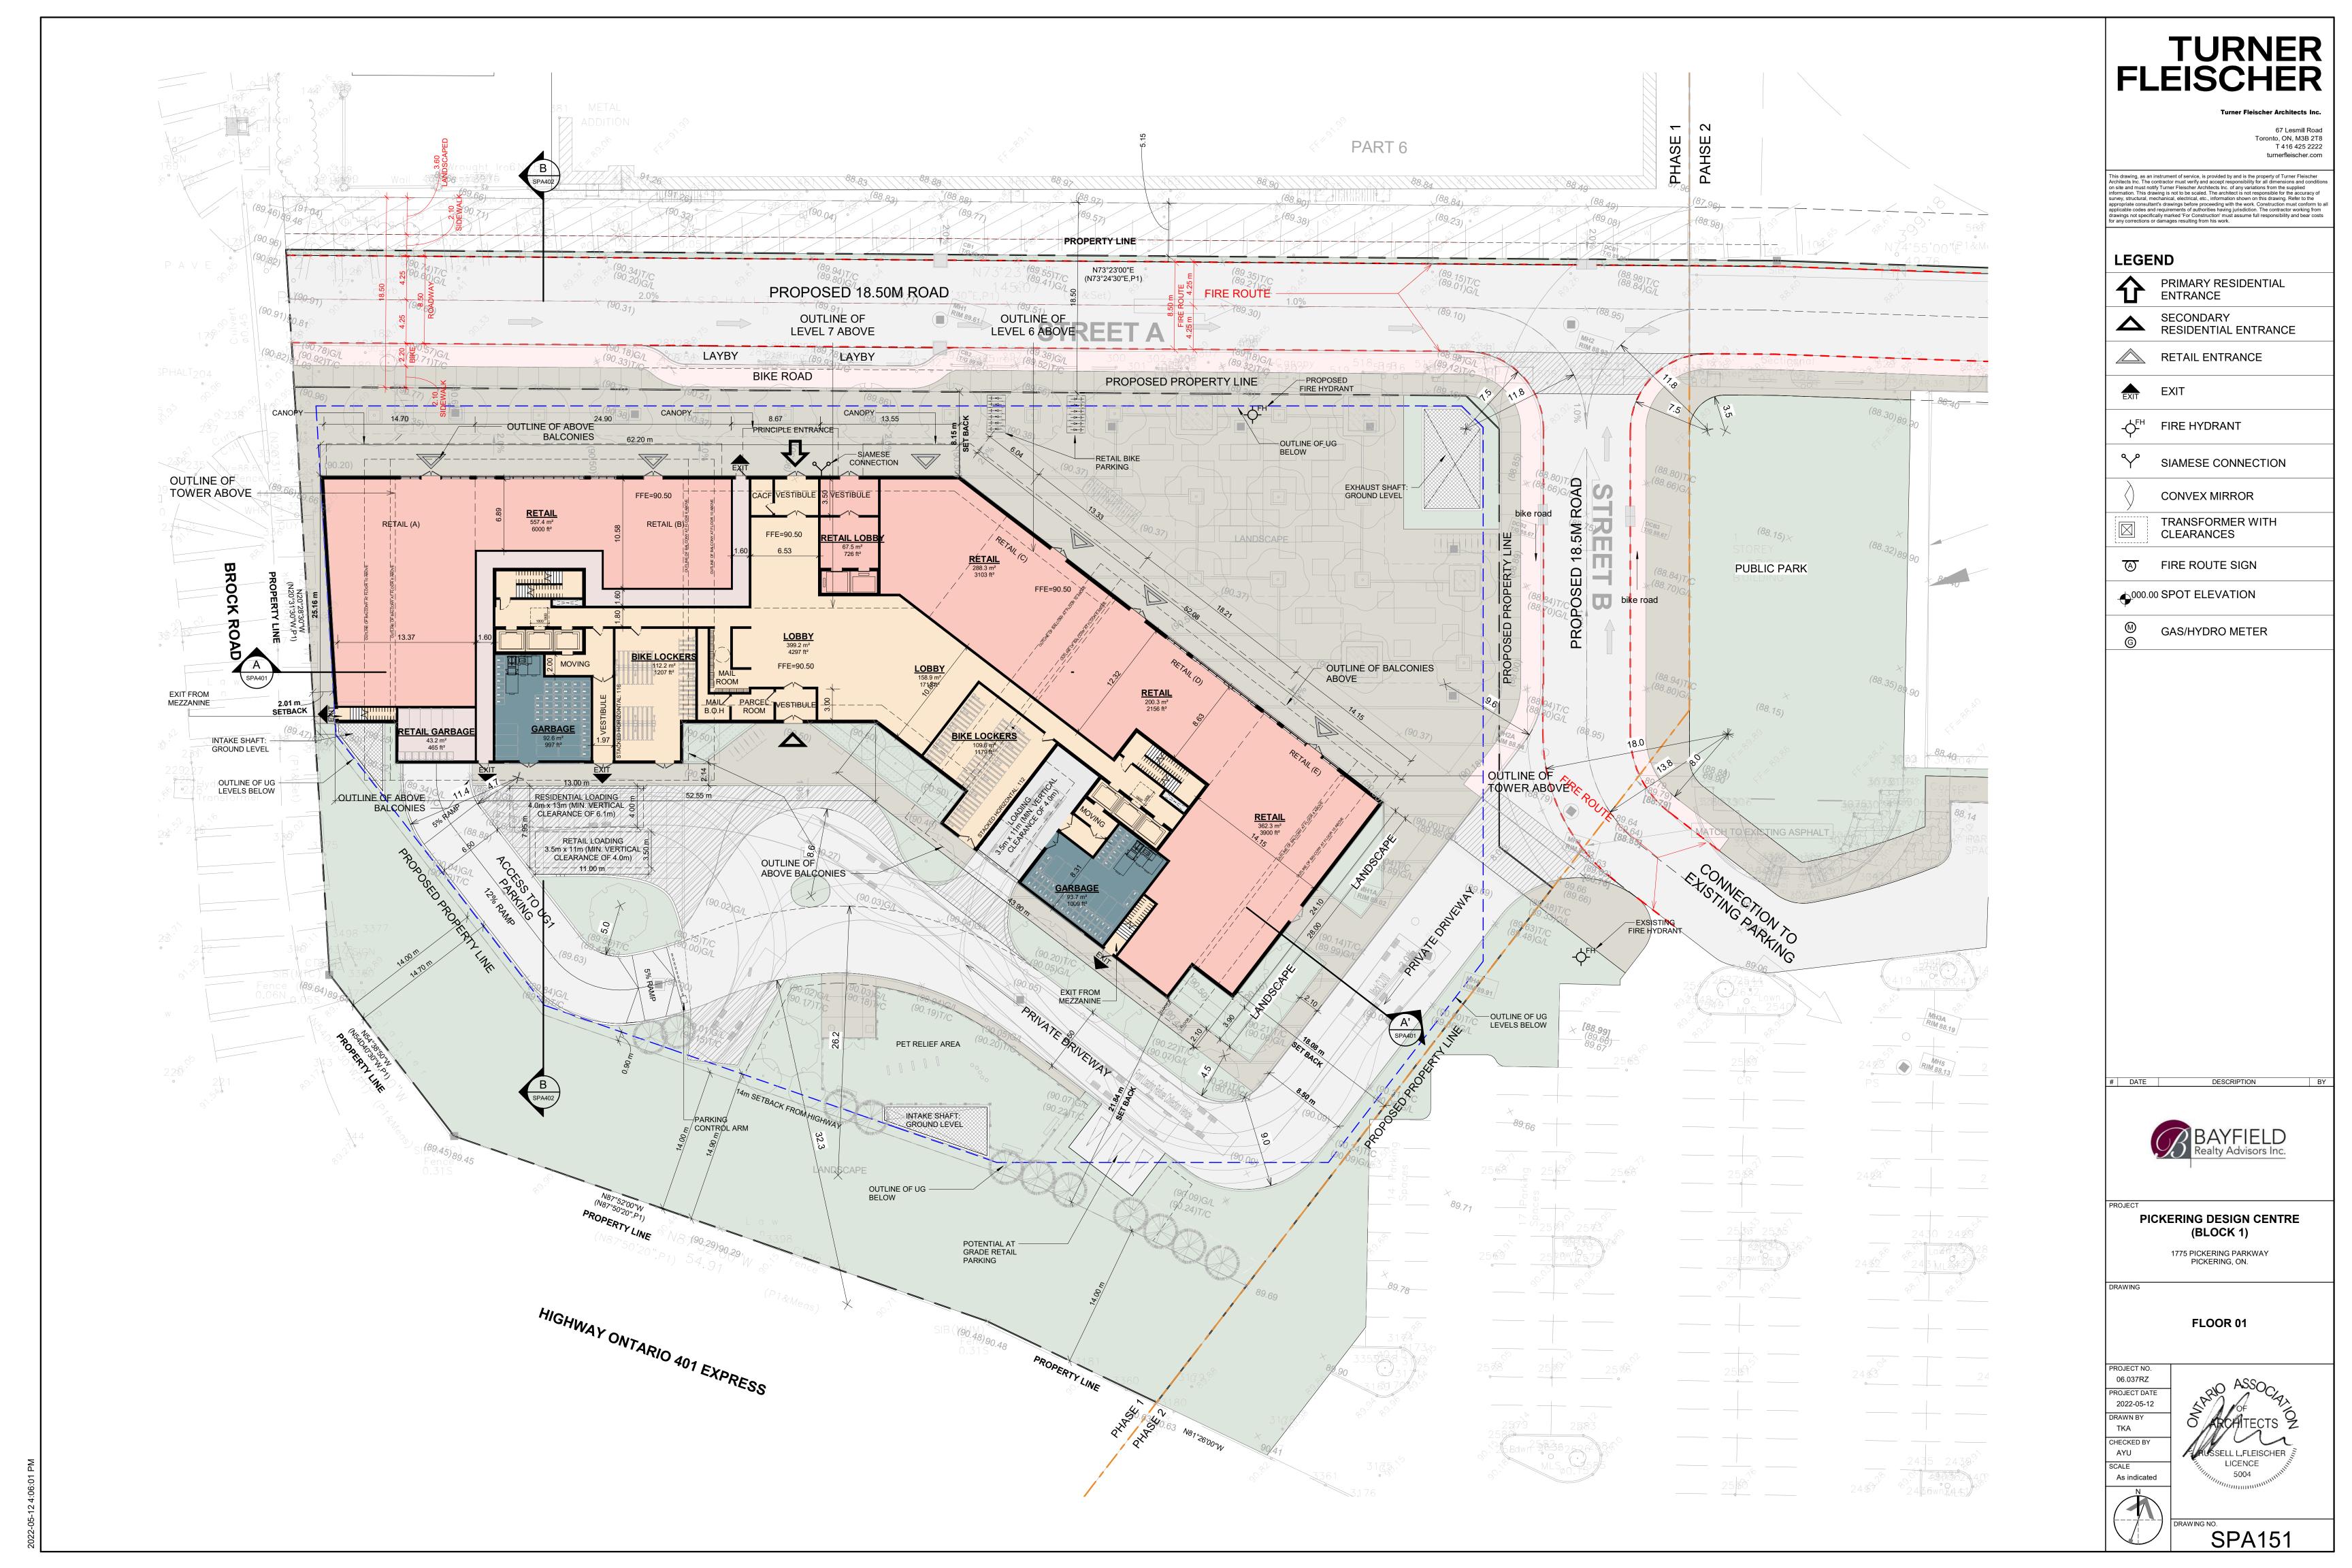
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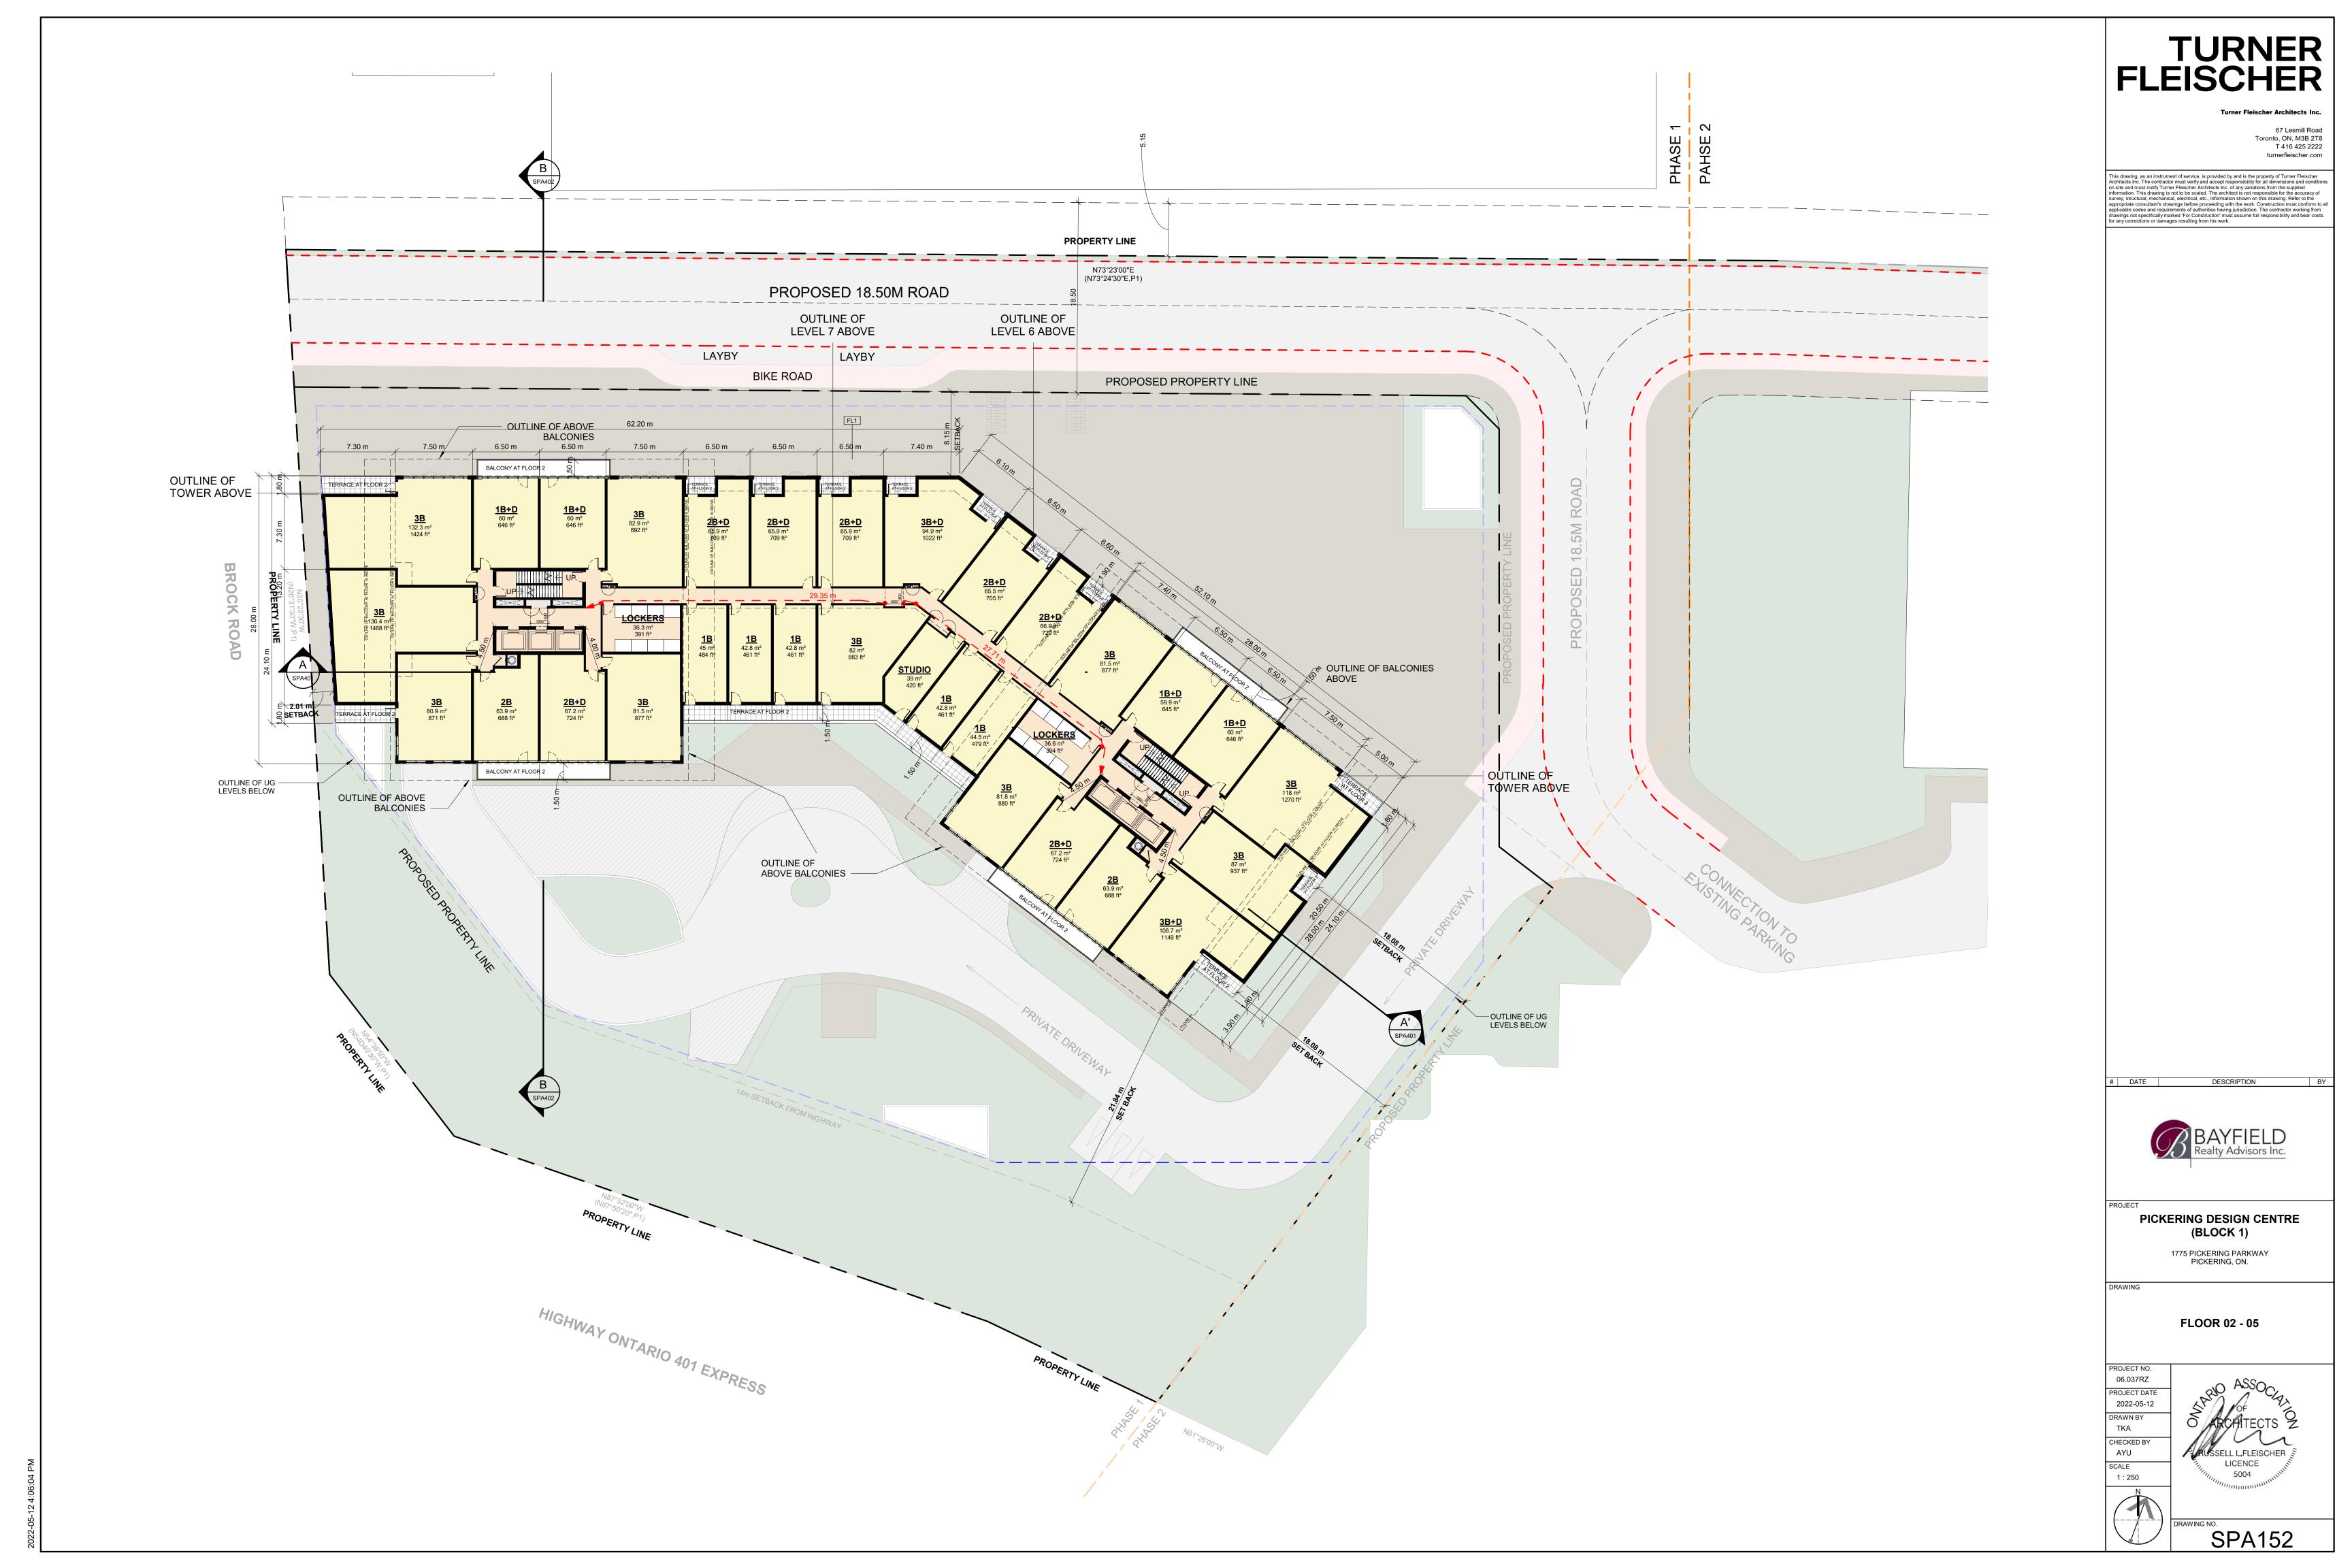

















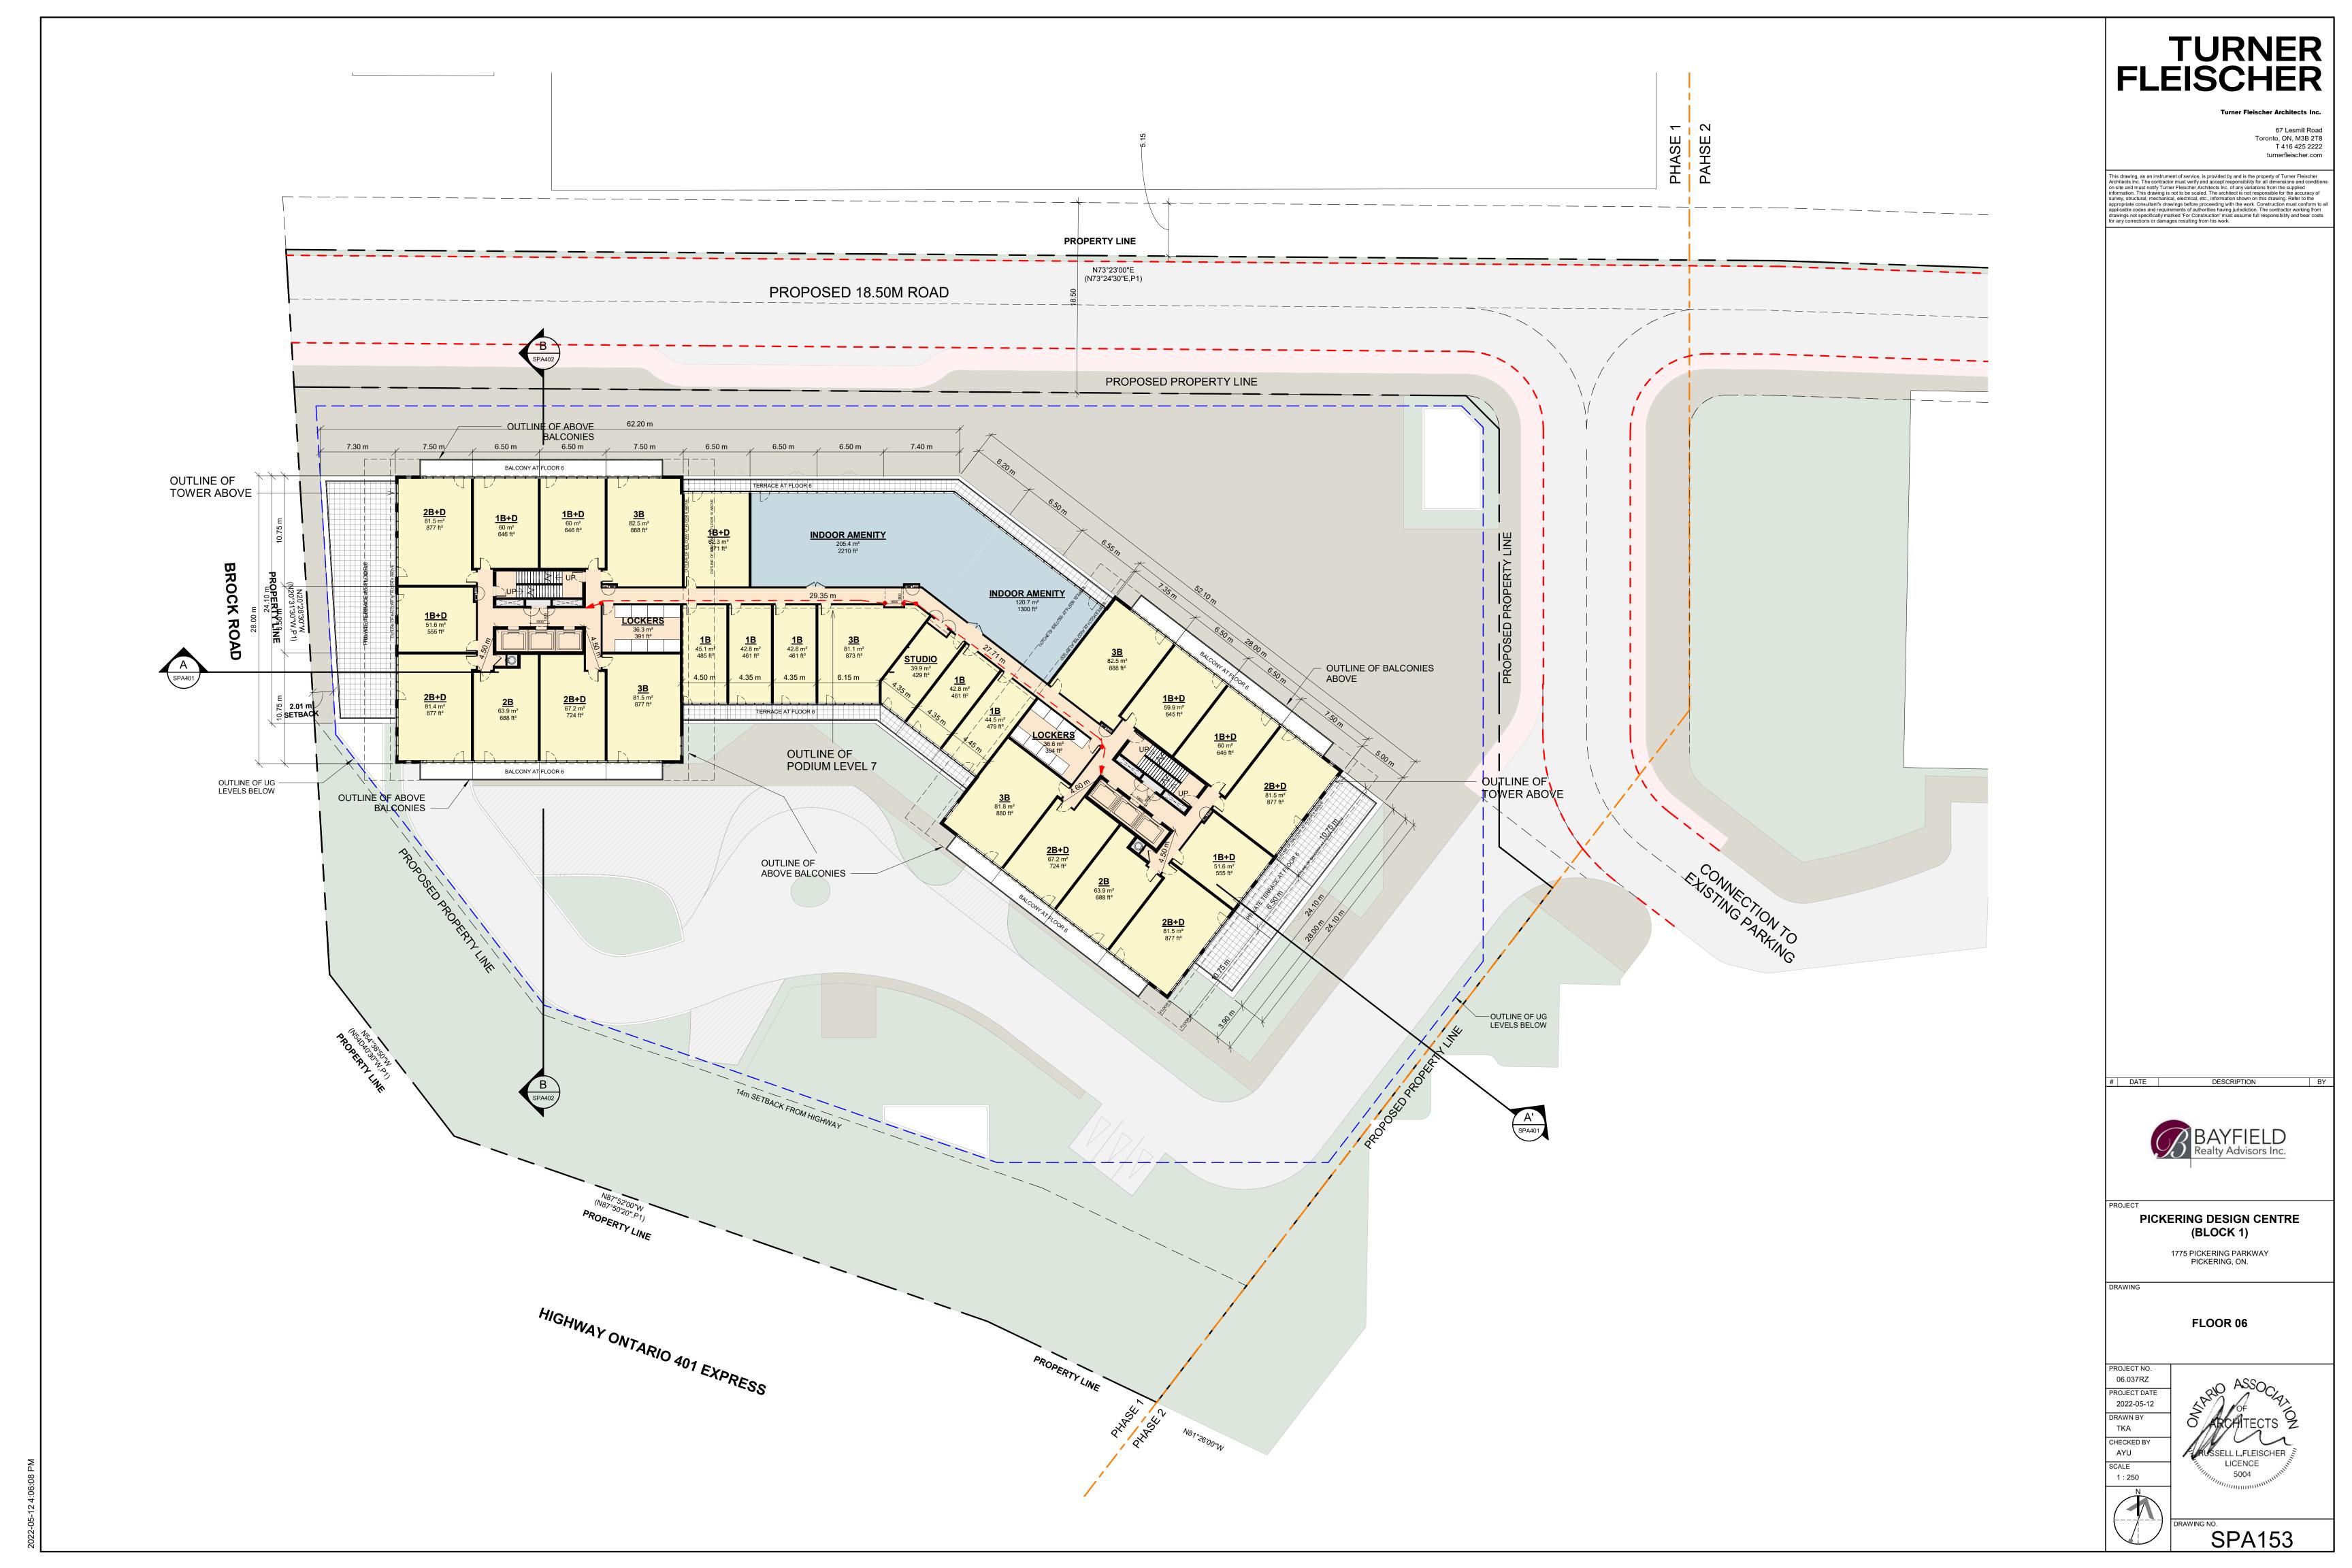

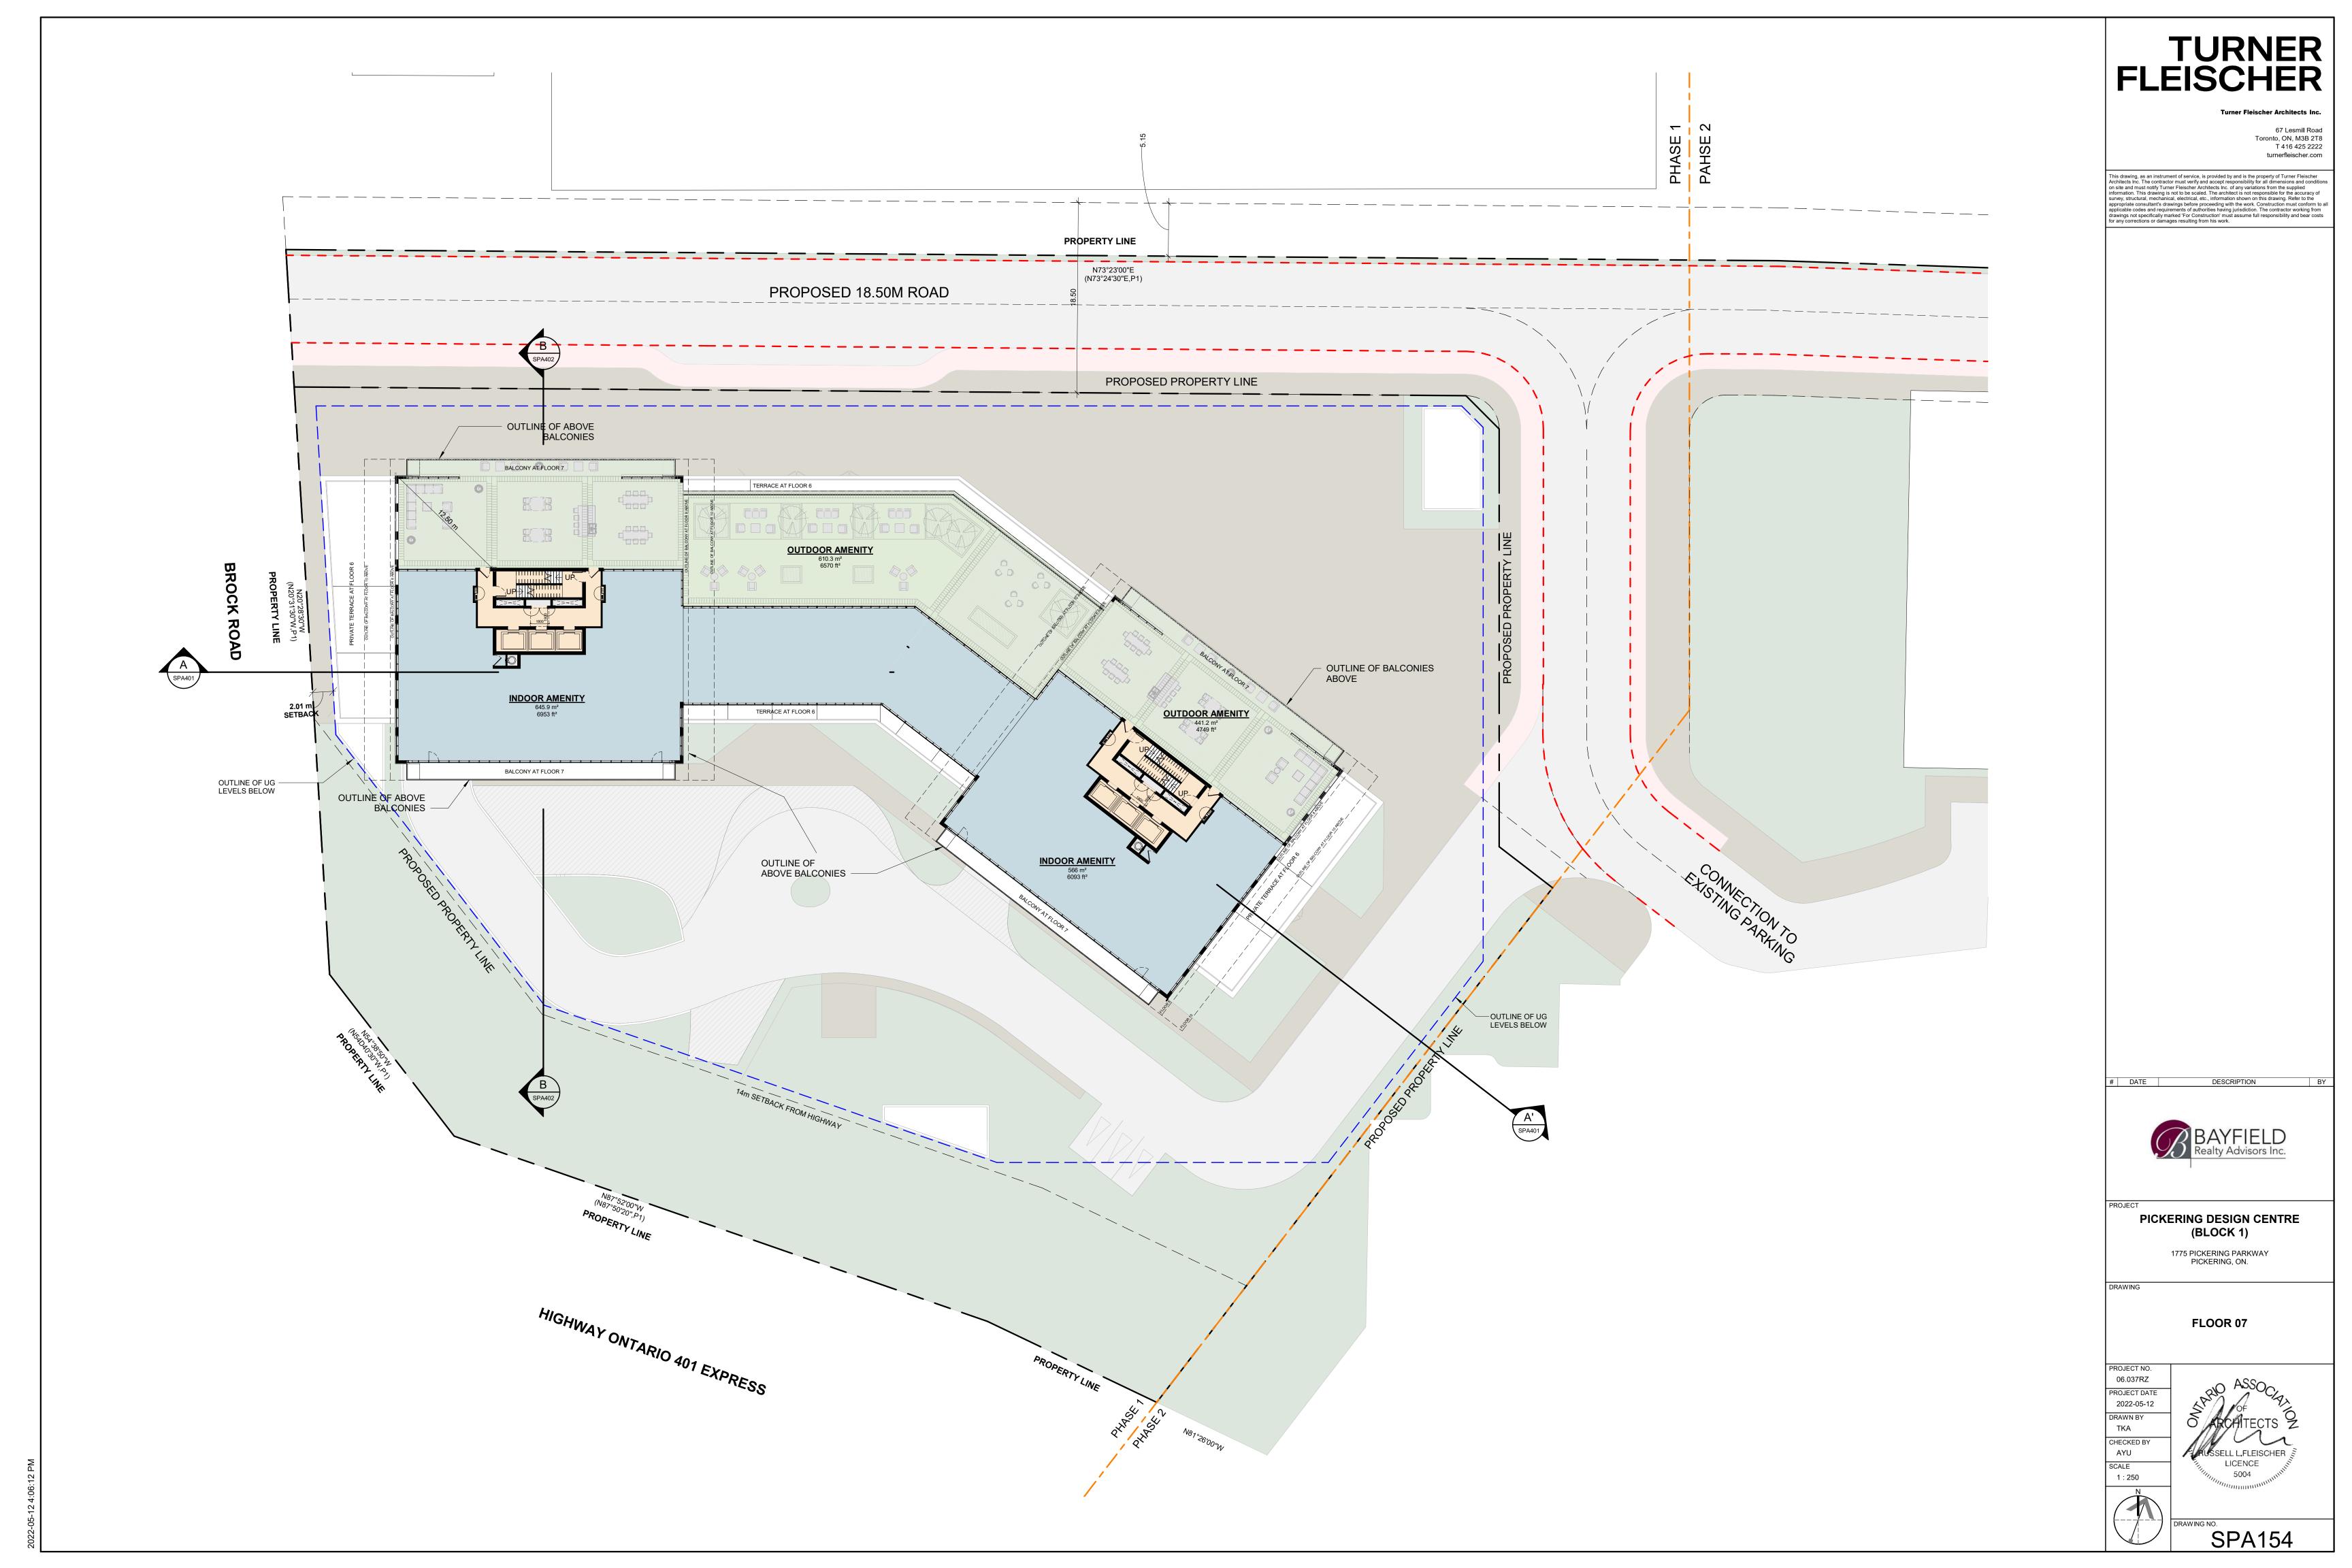

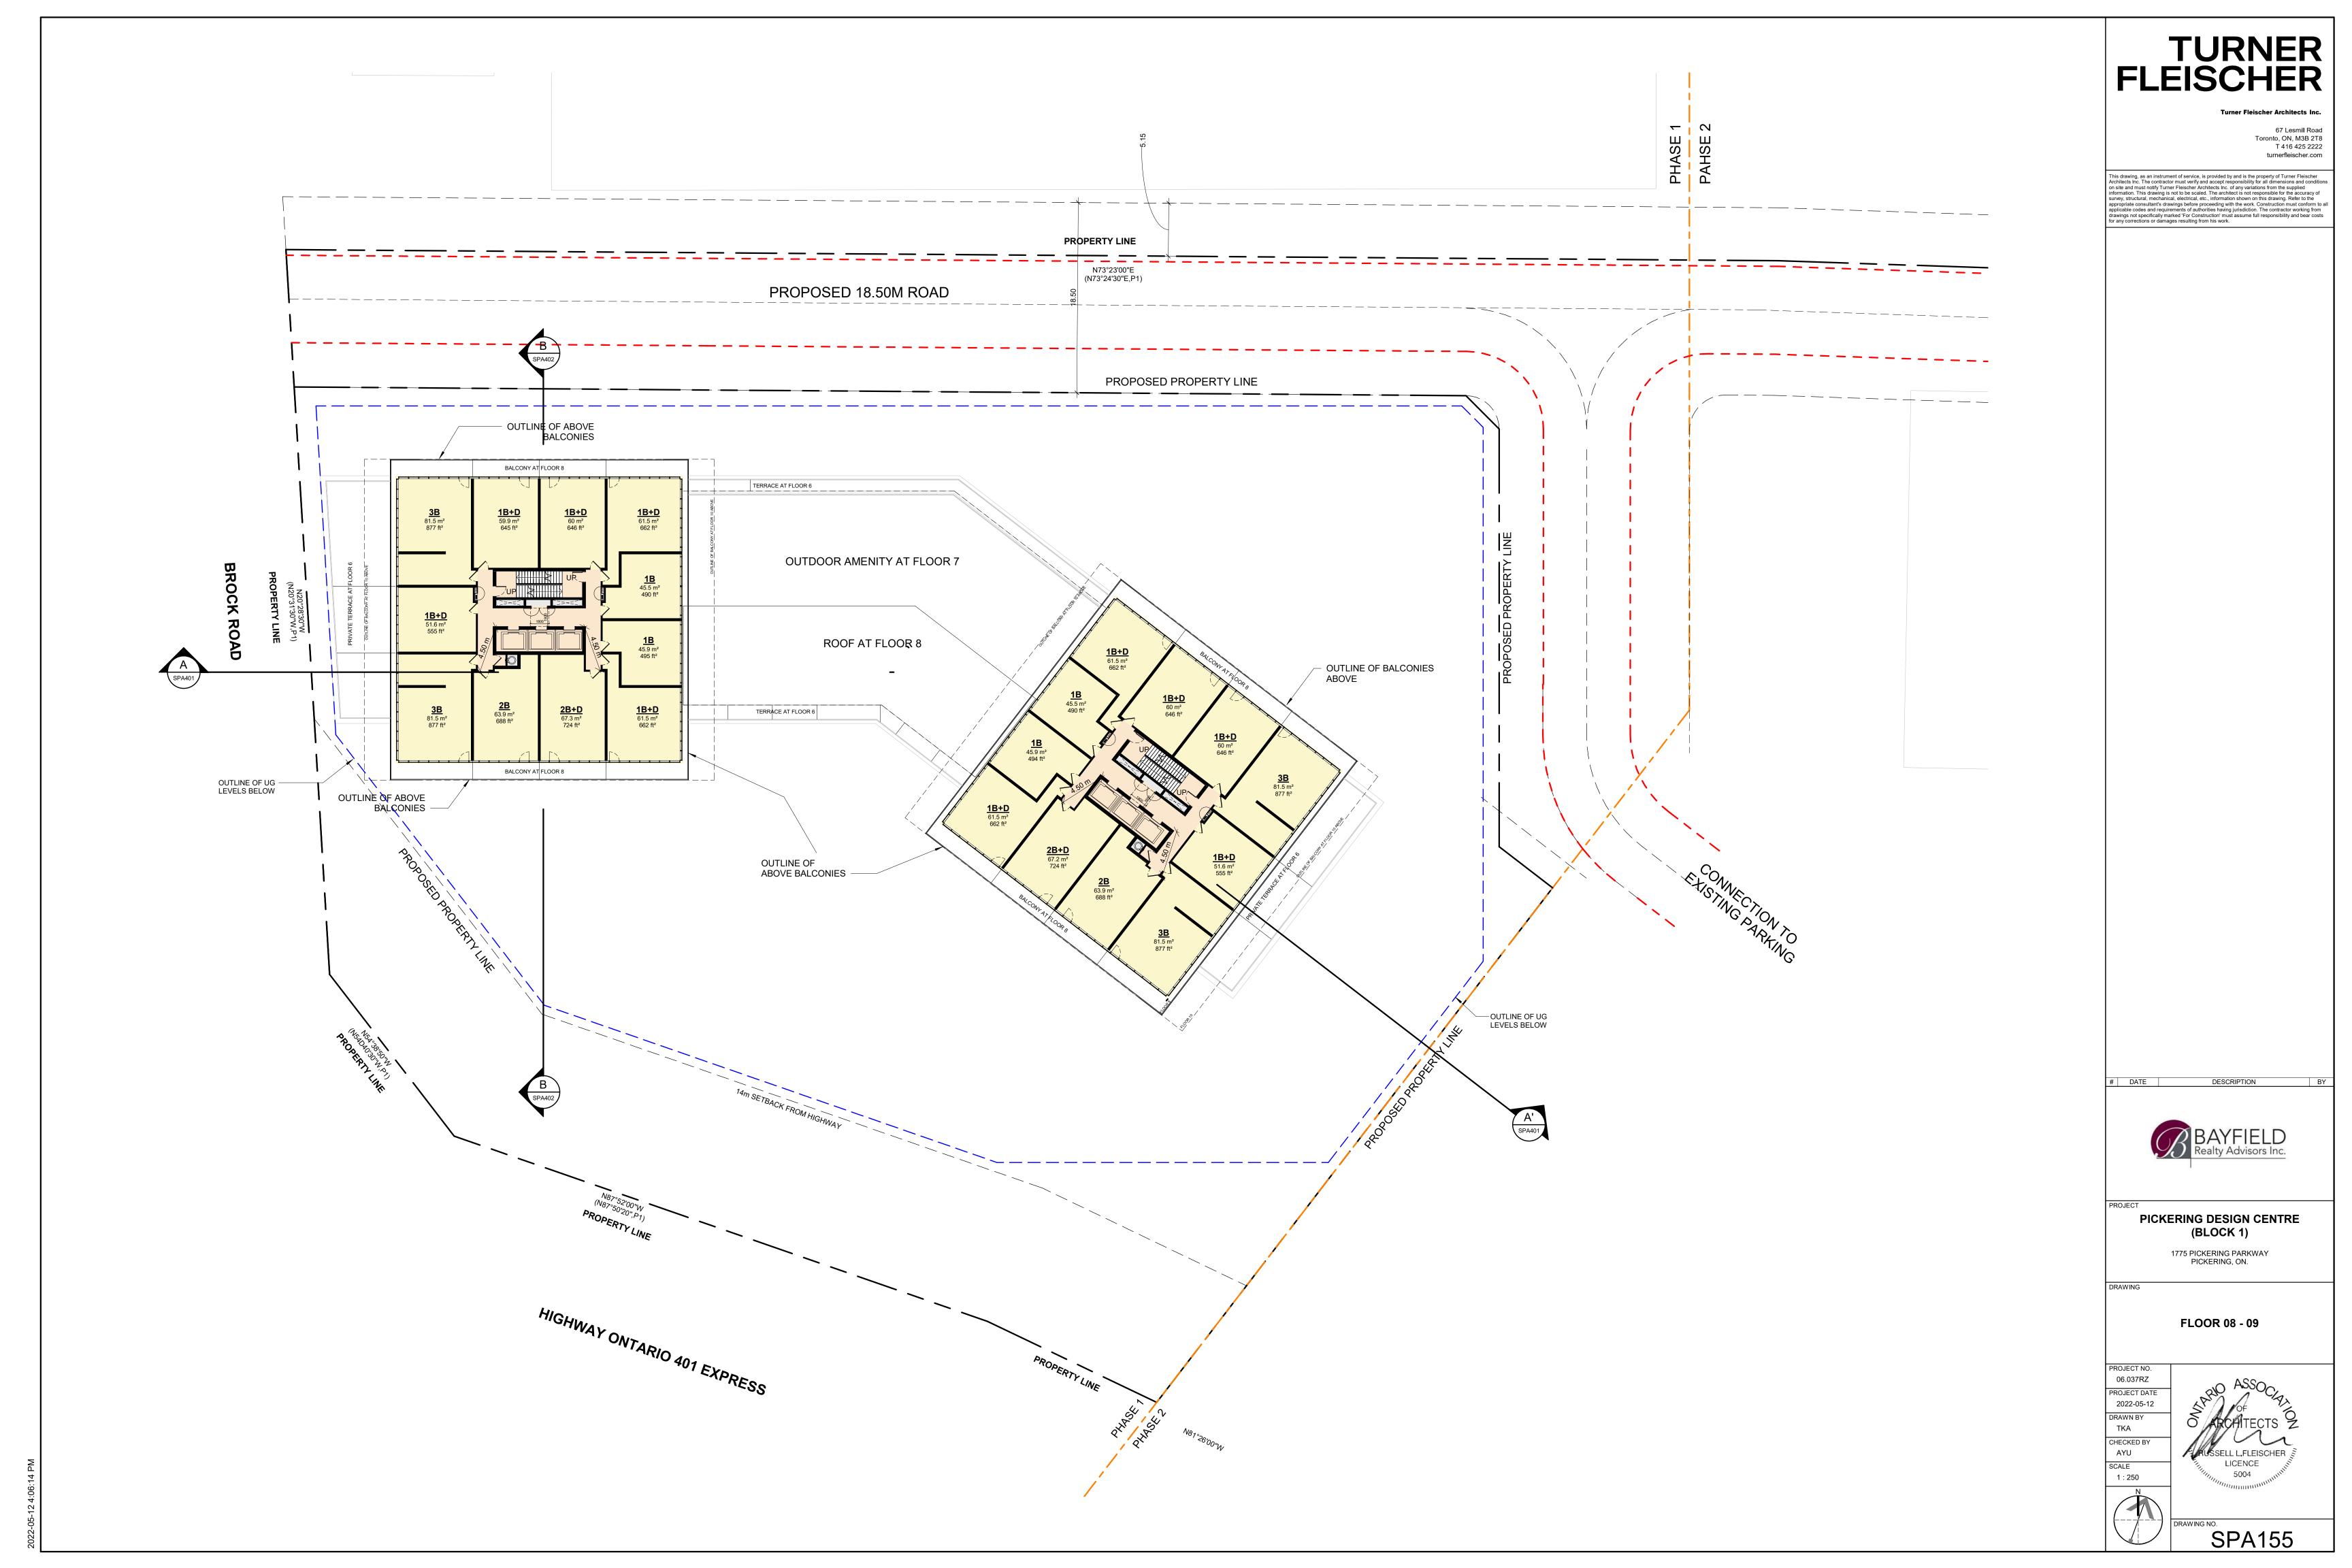

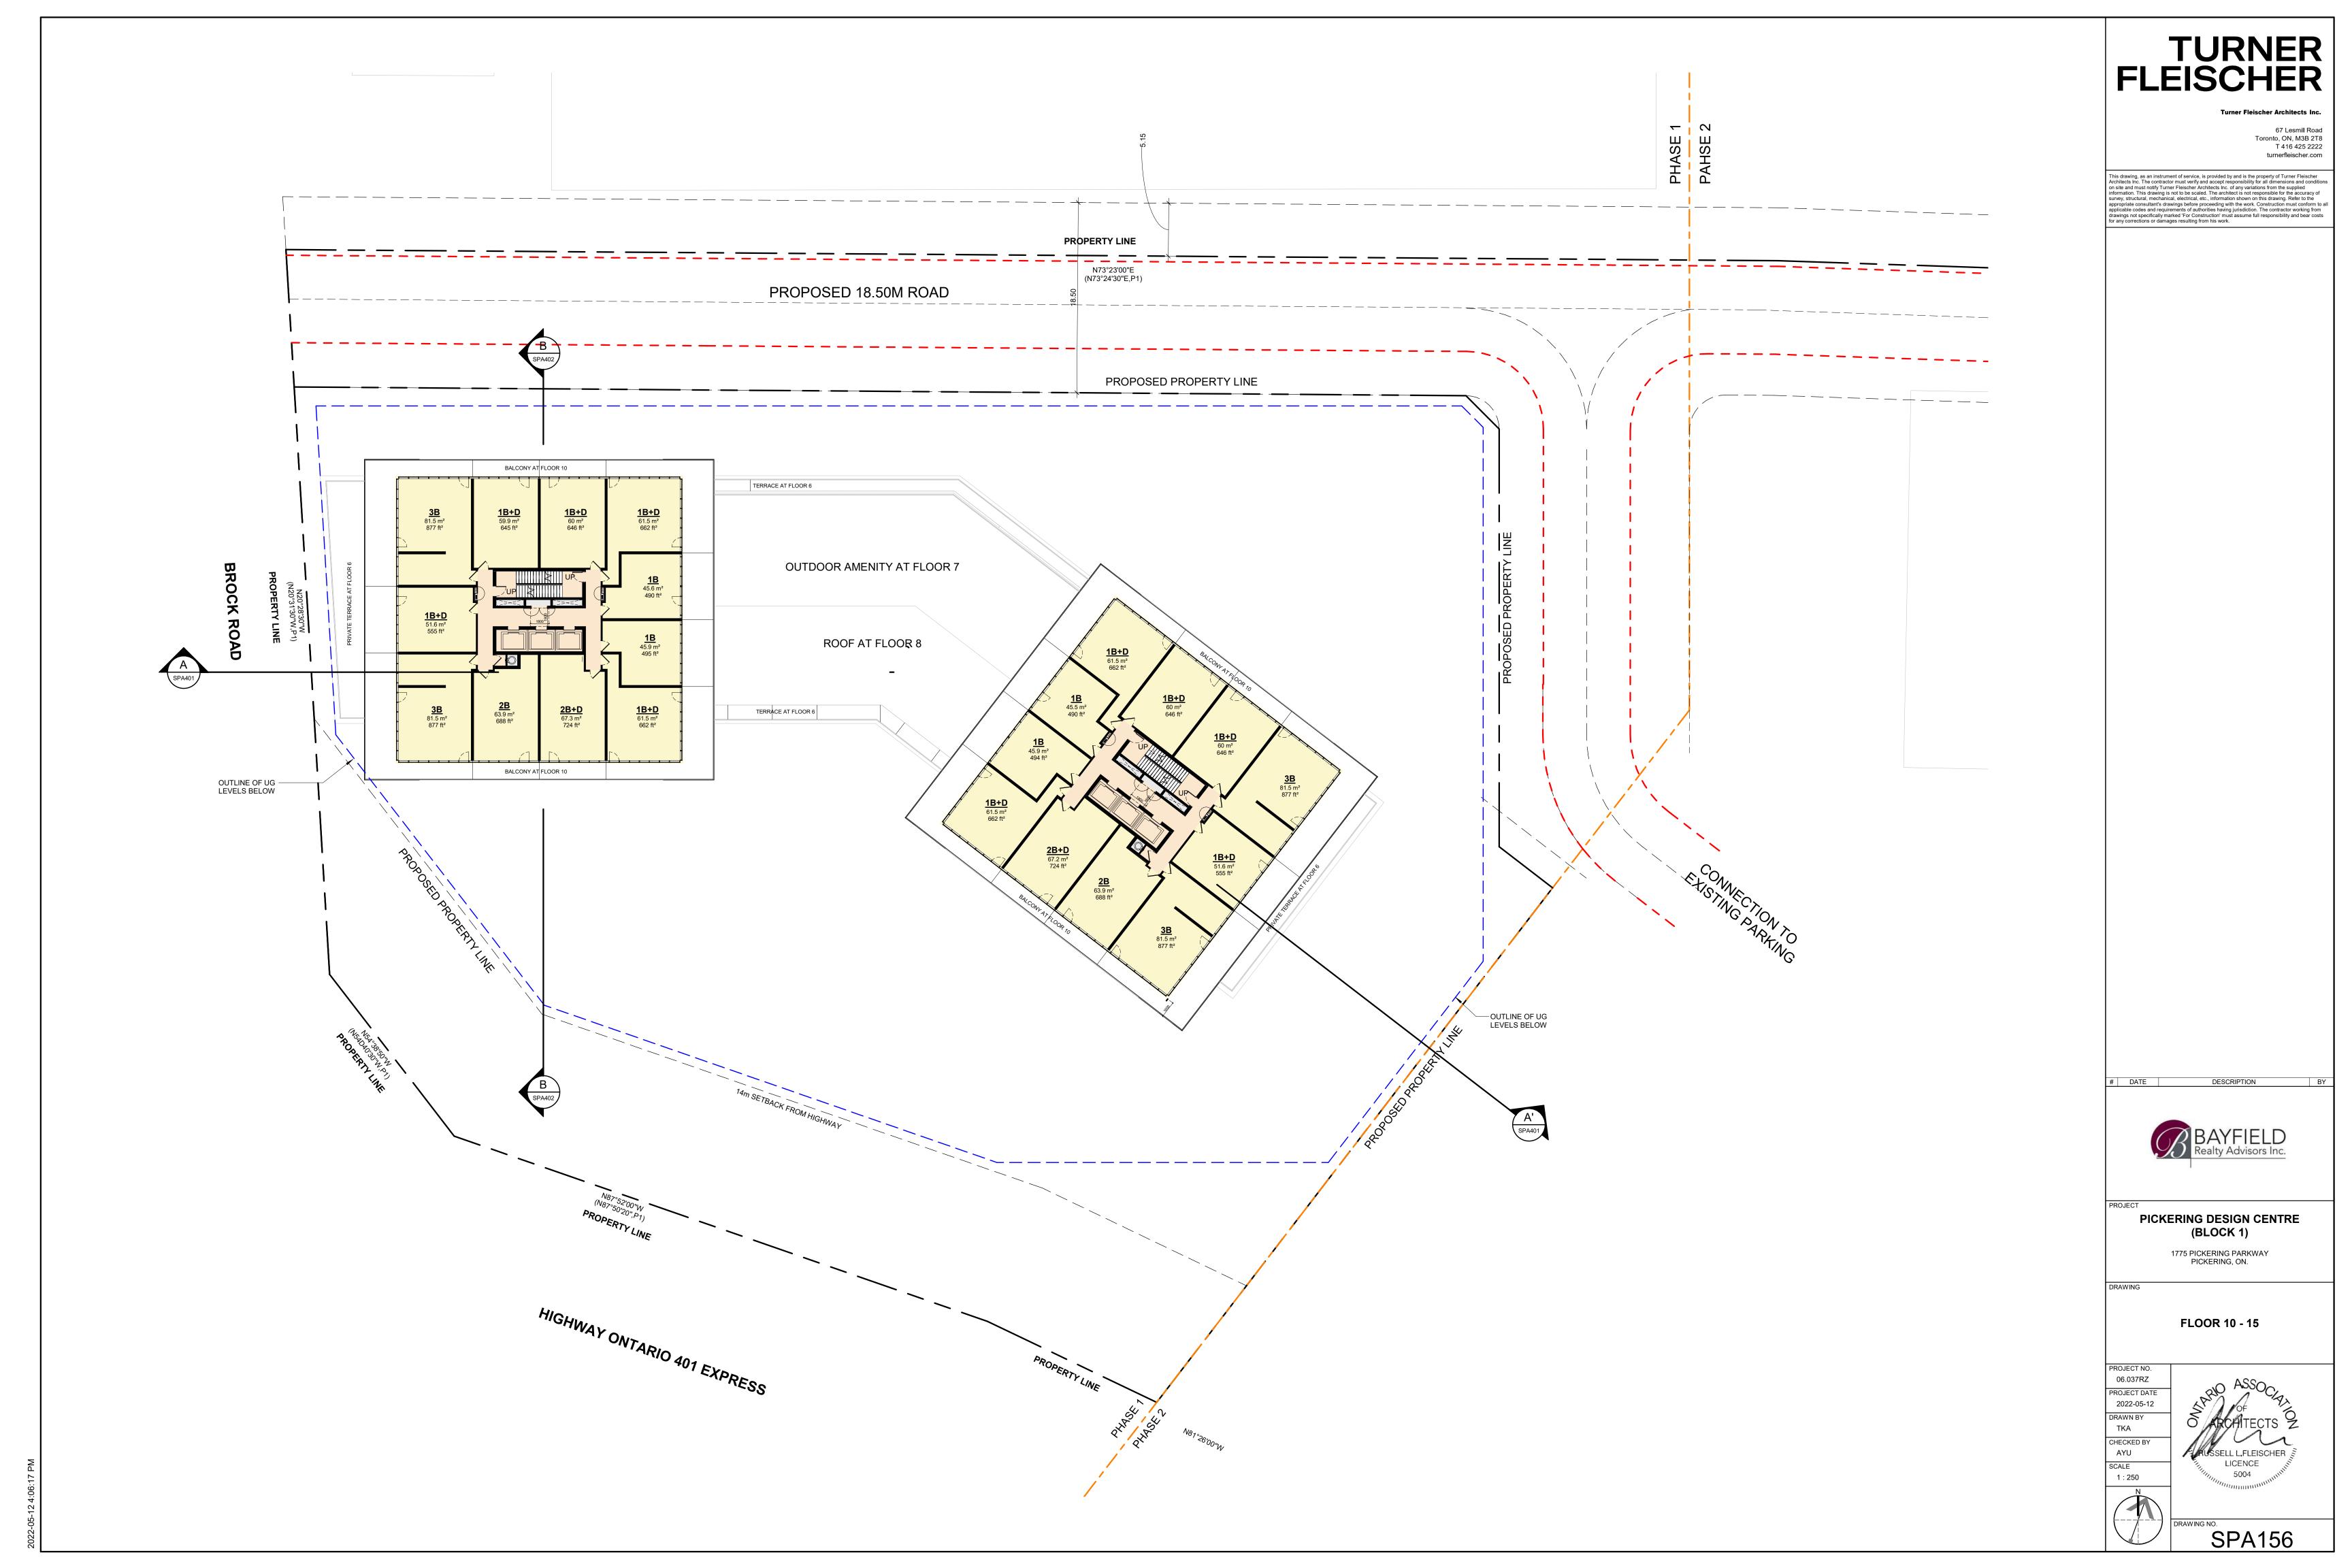

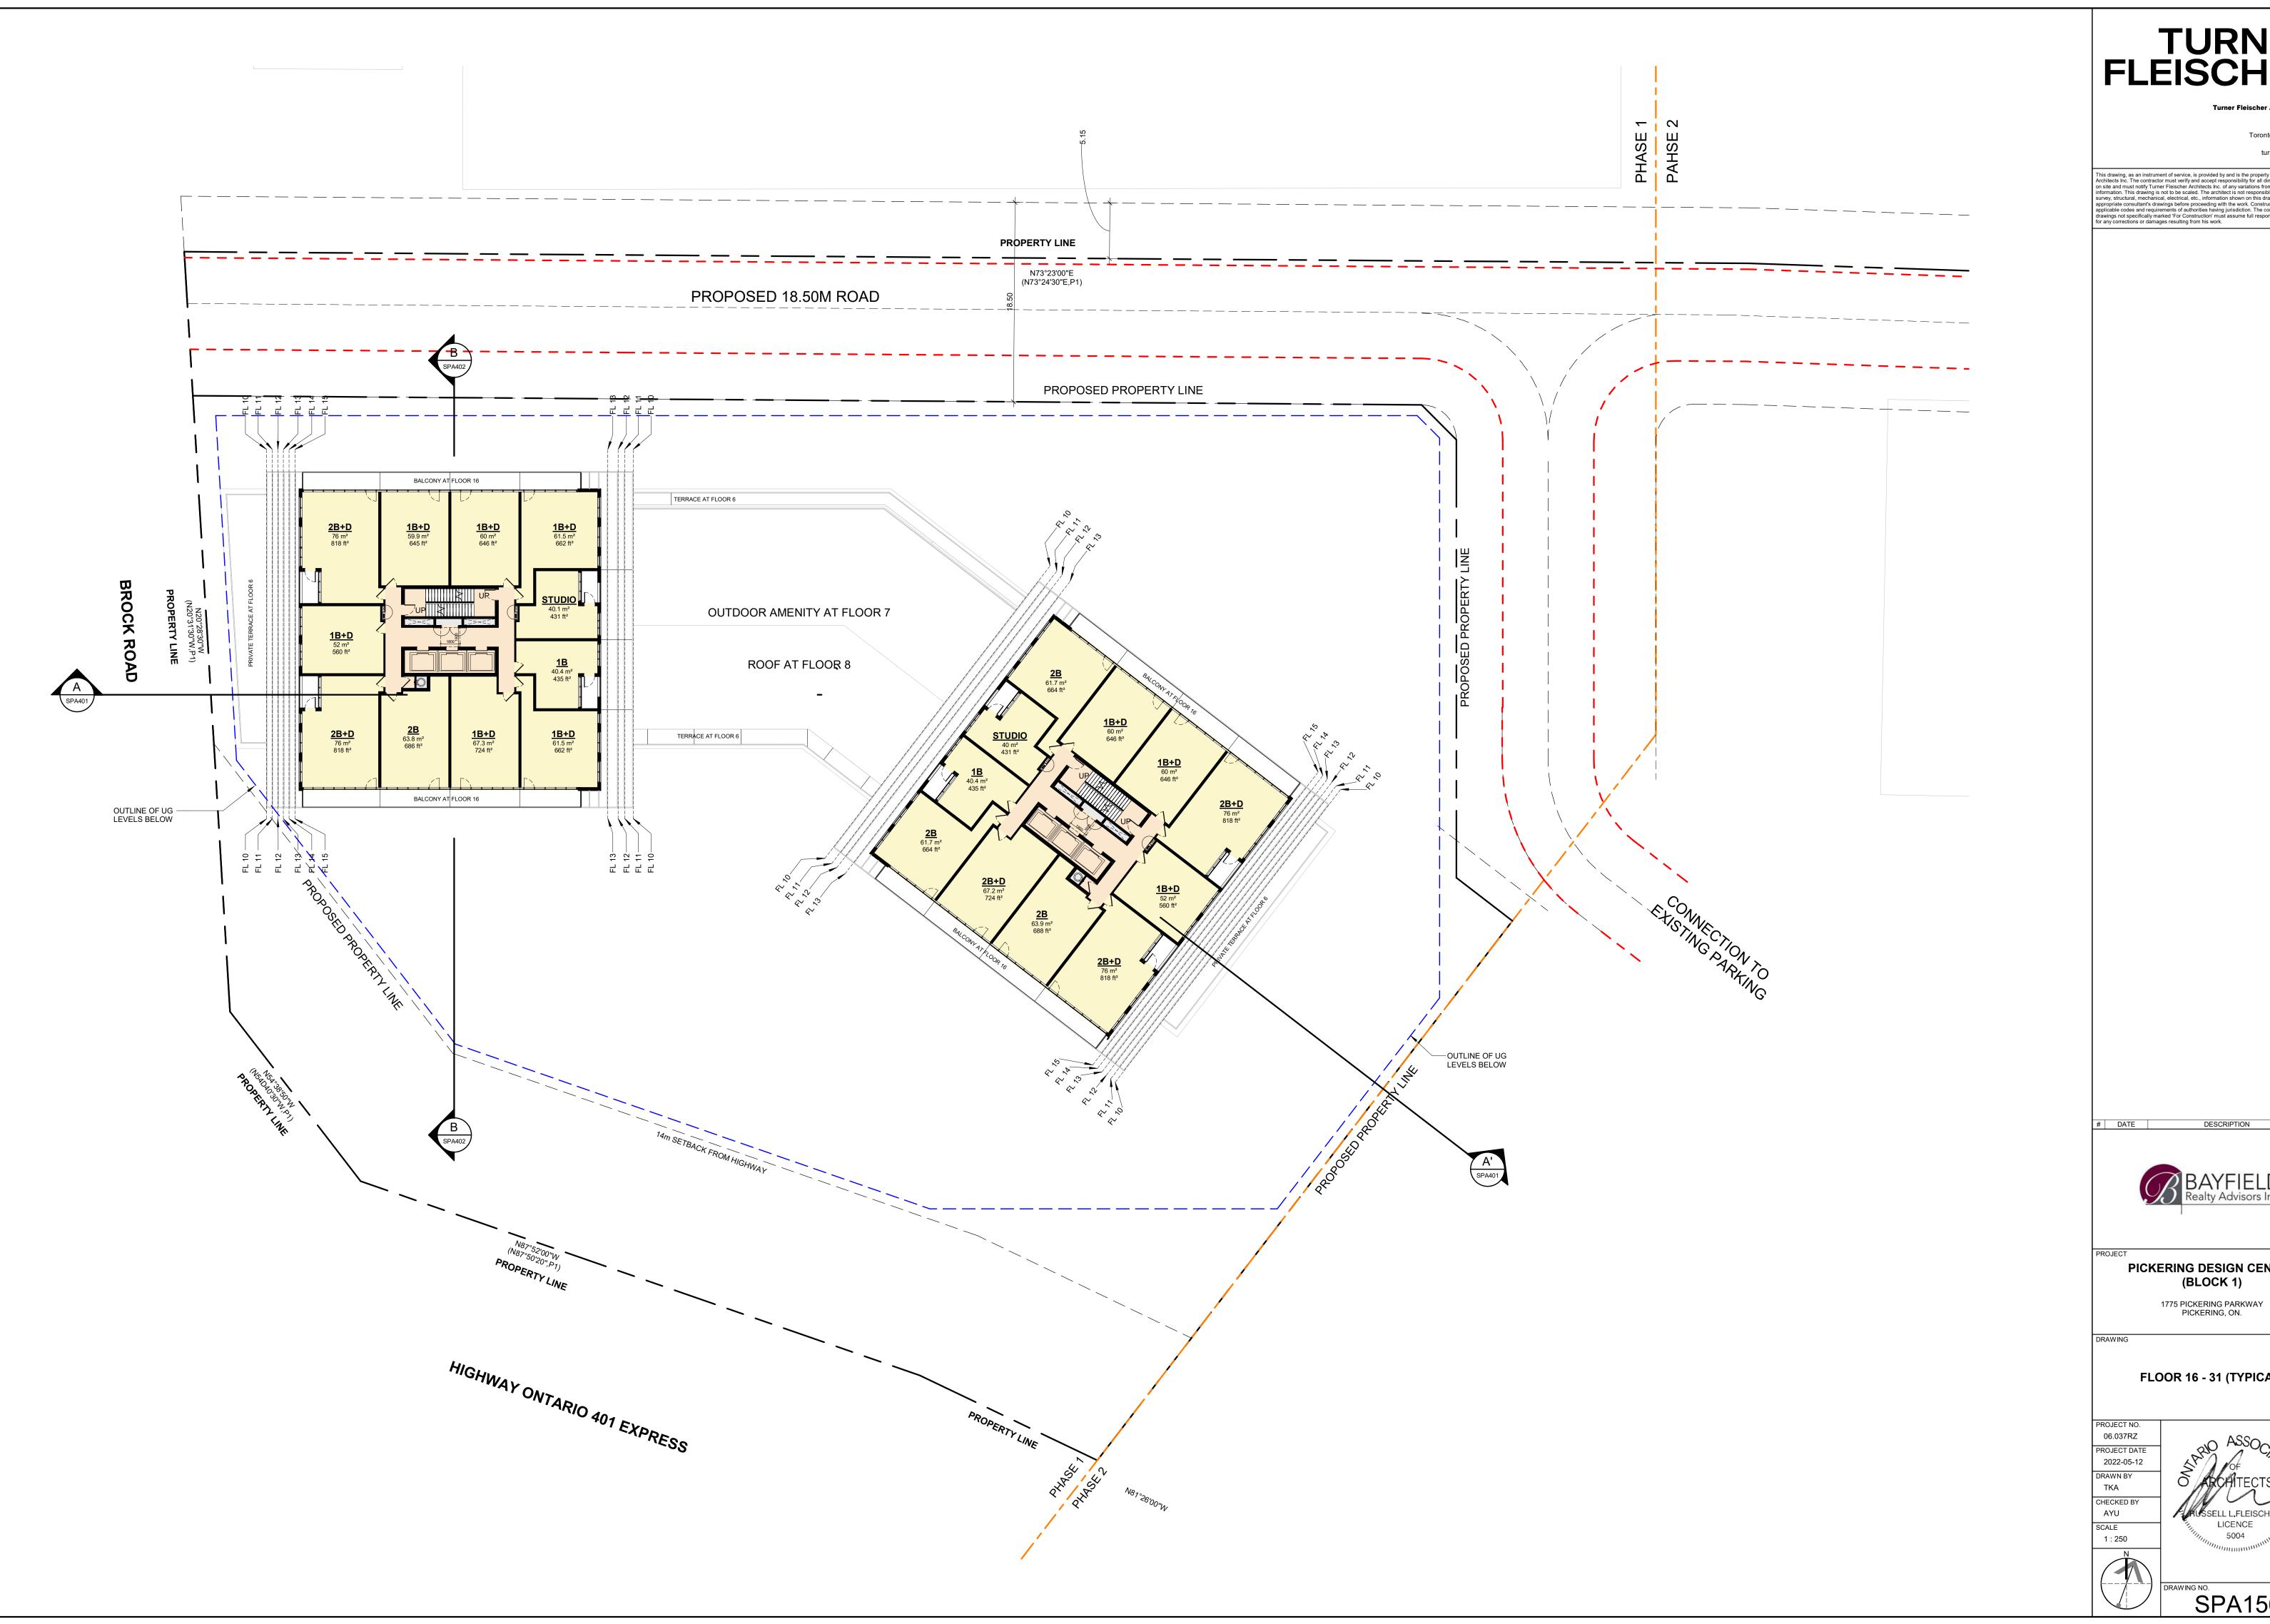

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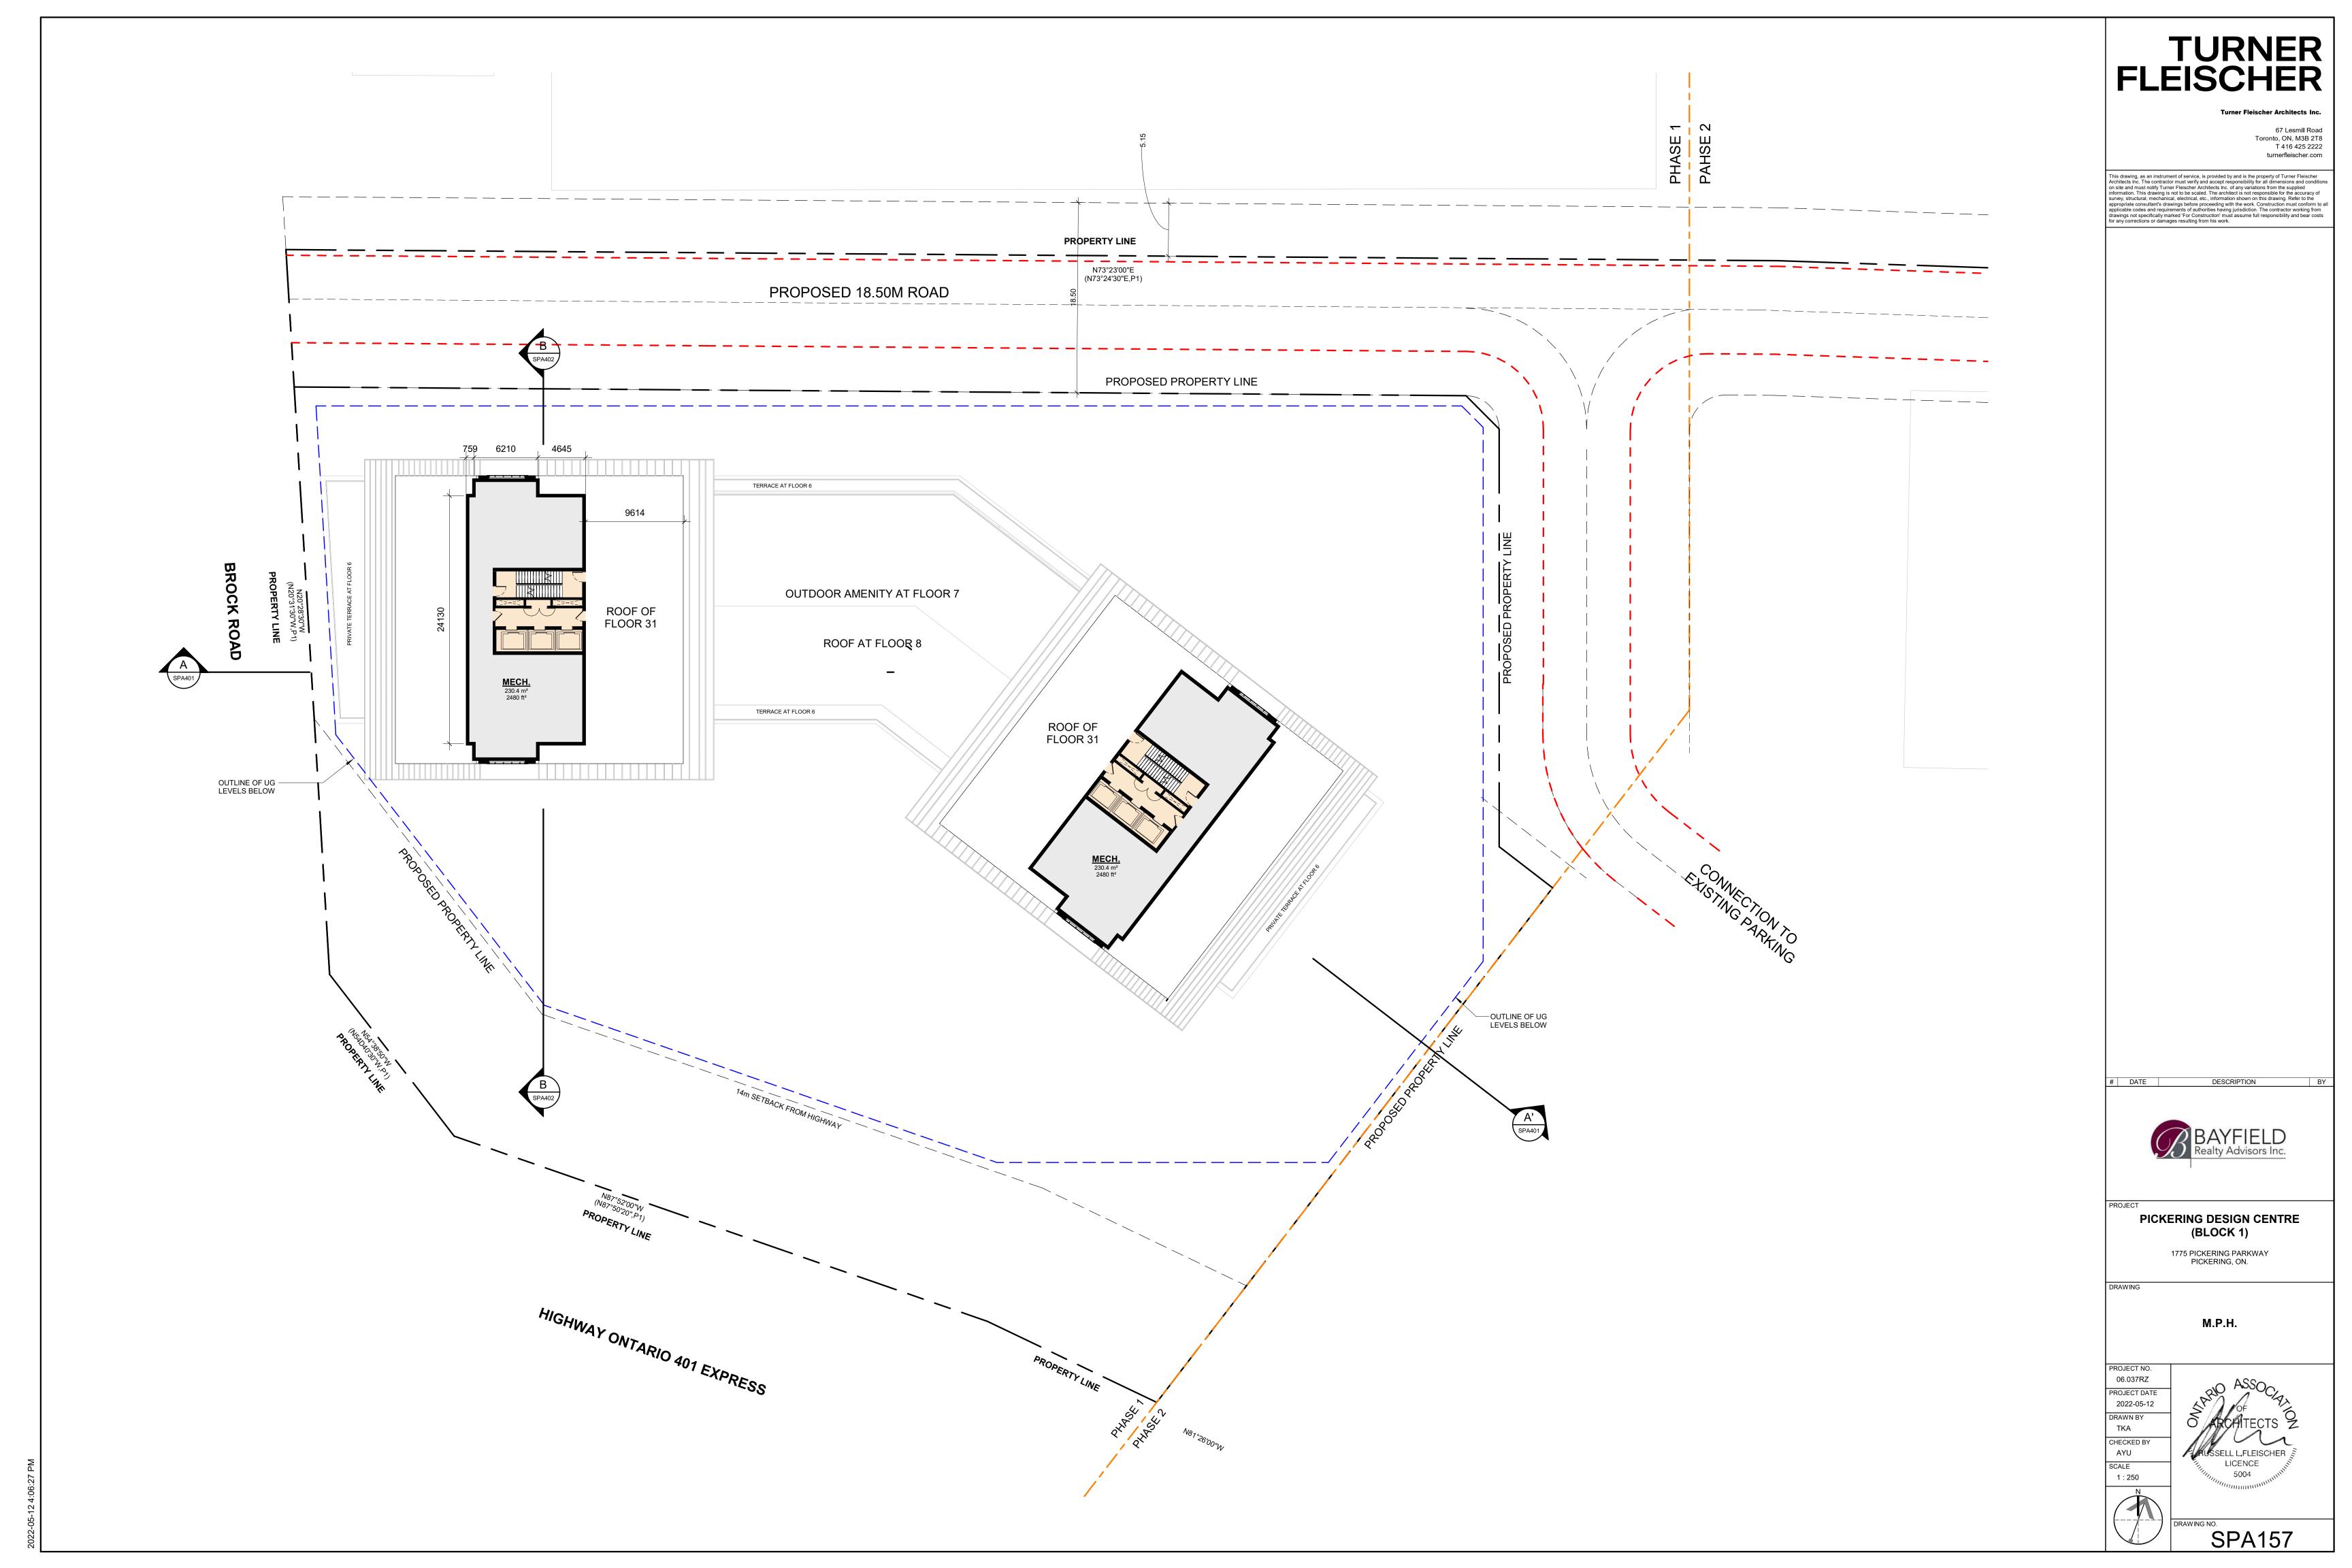
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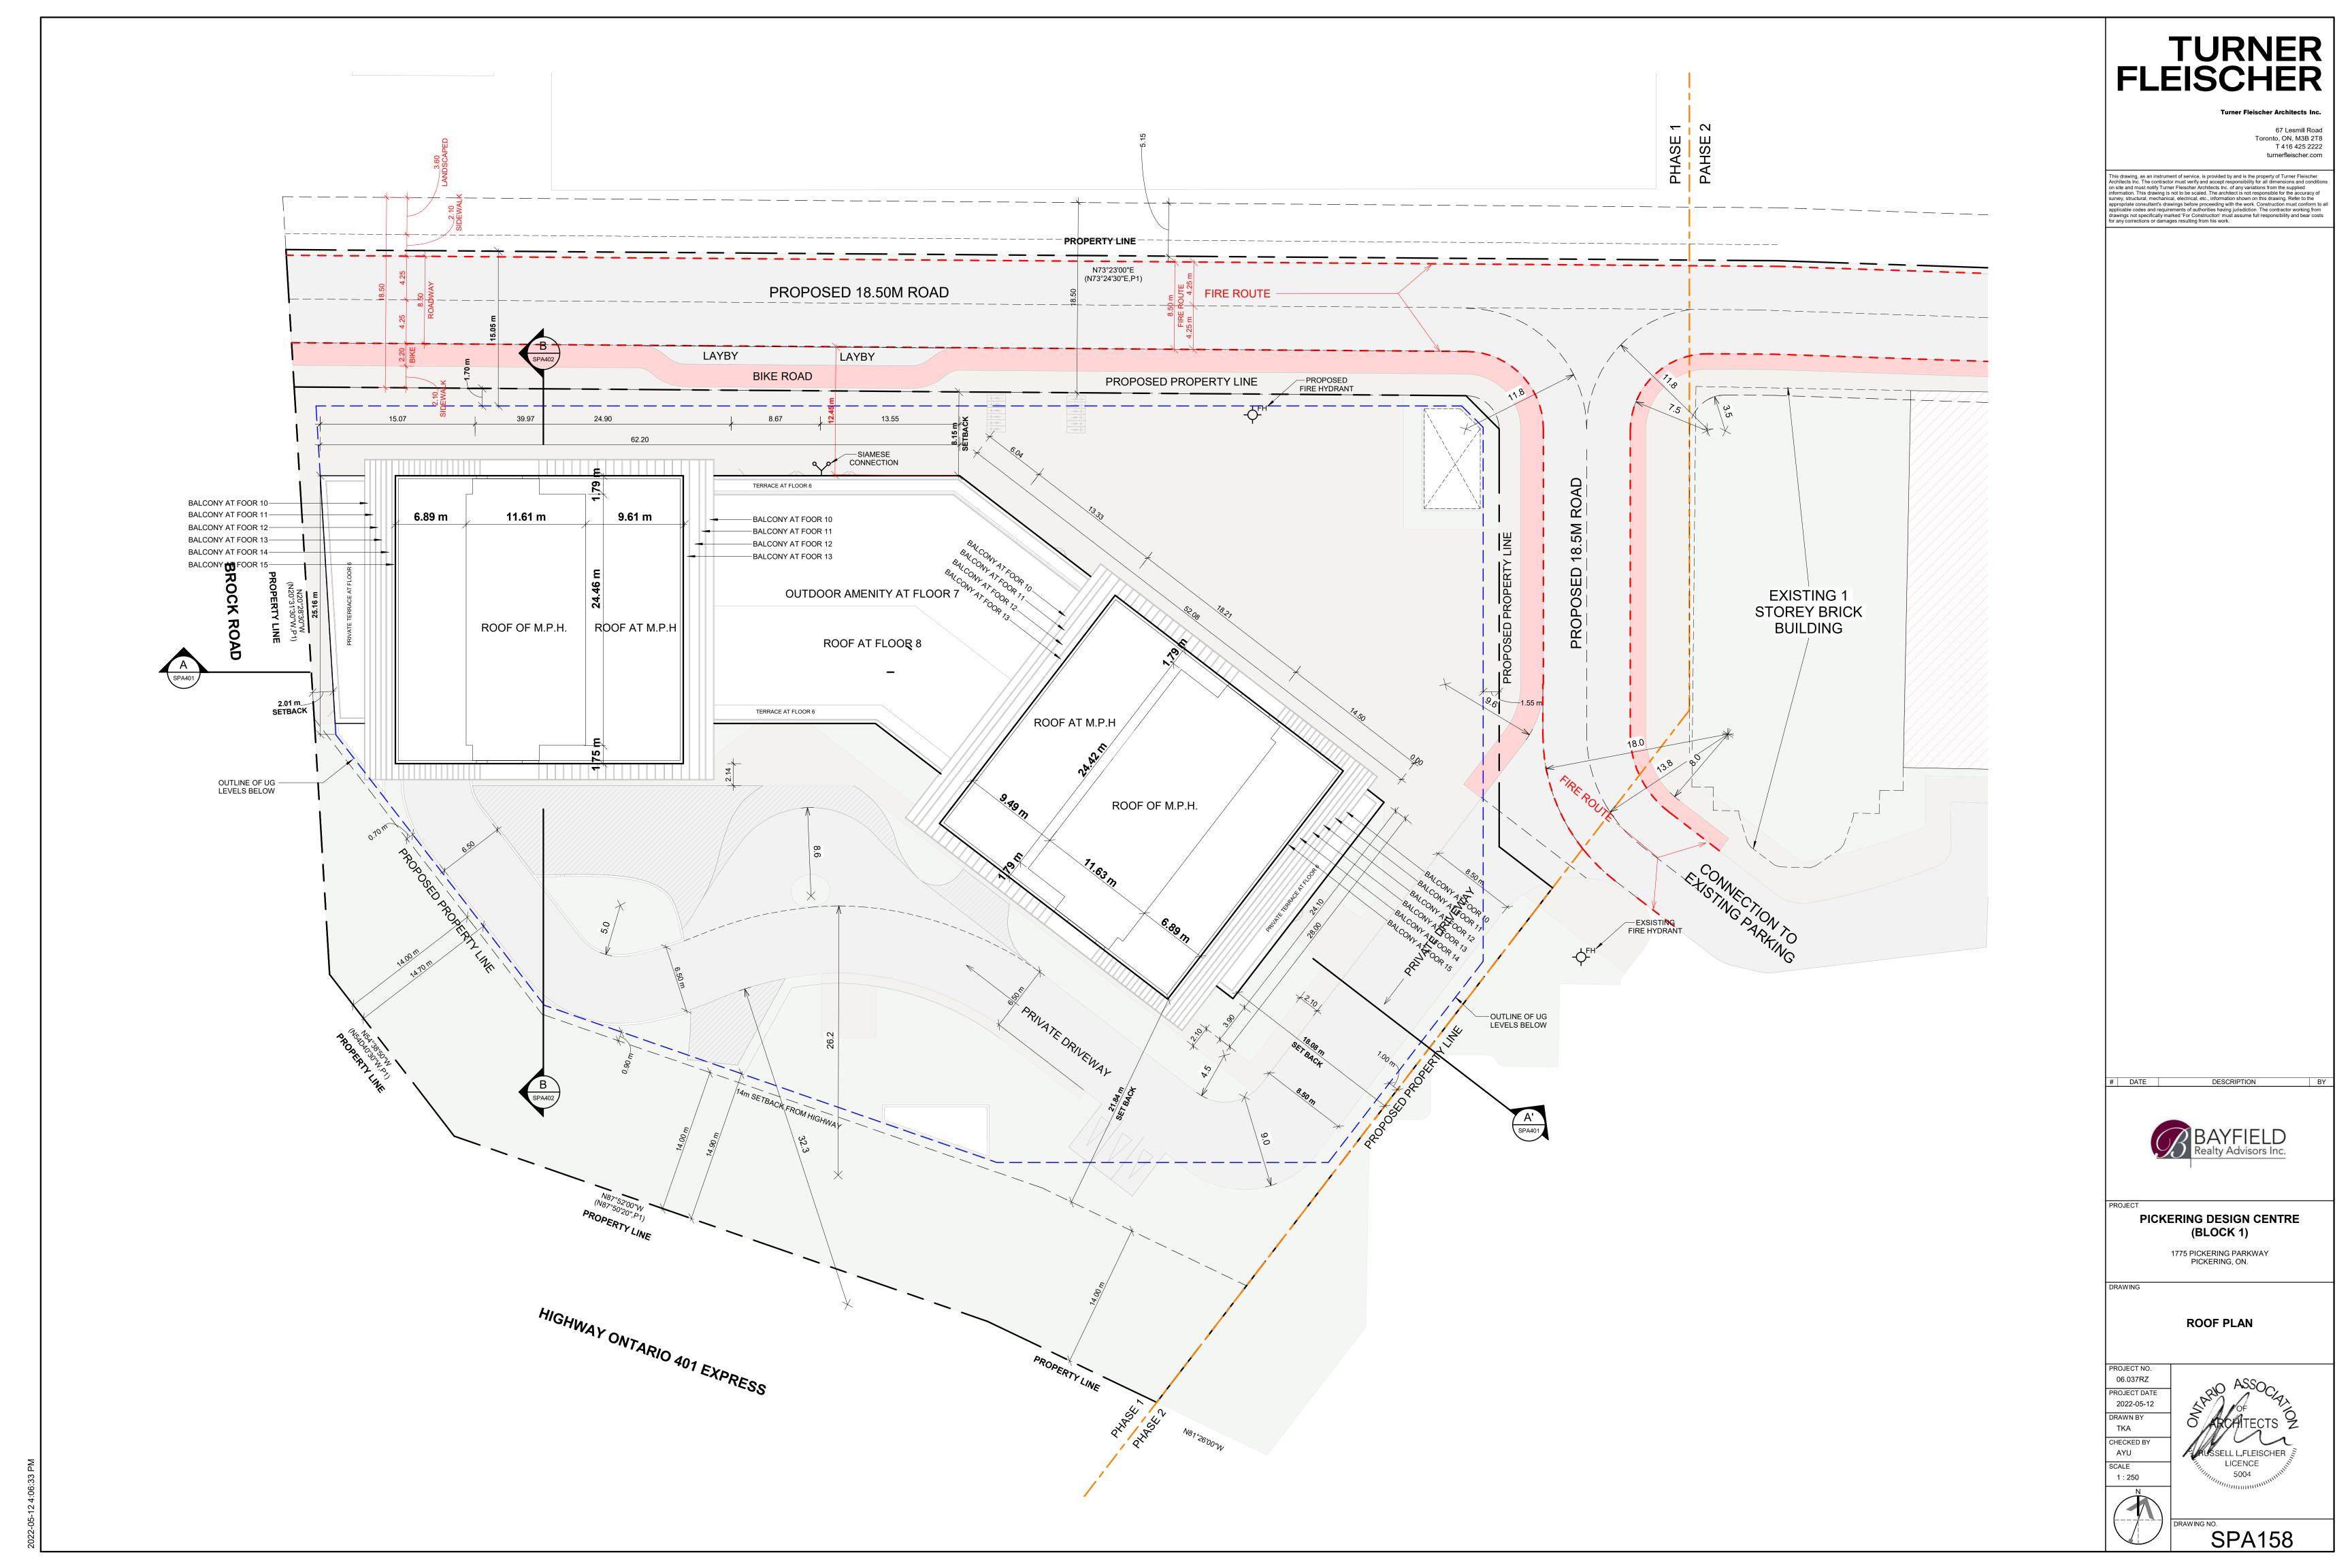



PICKERING DESIGN CENTRE (BLOCK 1)

FLOOR 16 - 31 (TYPICAL)

SPA156B





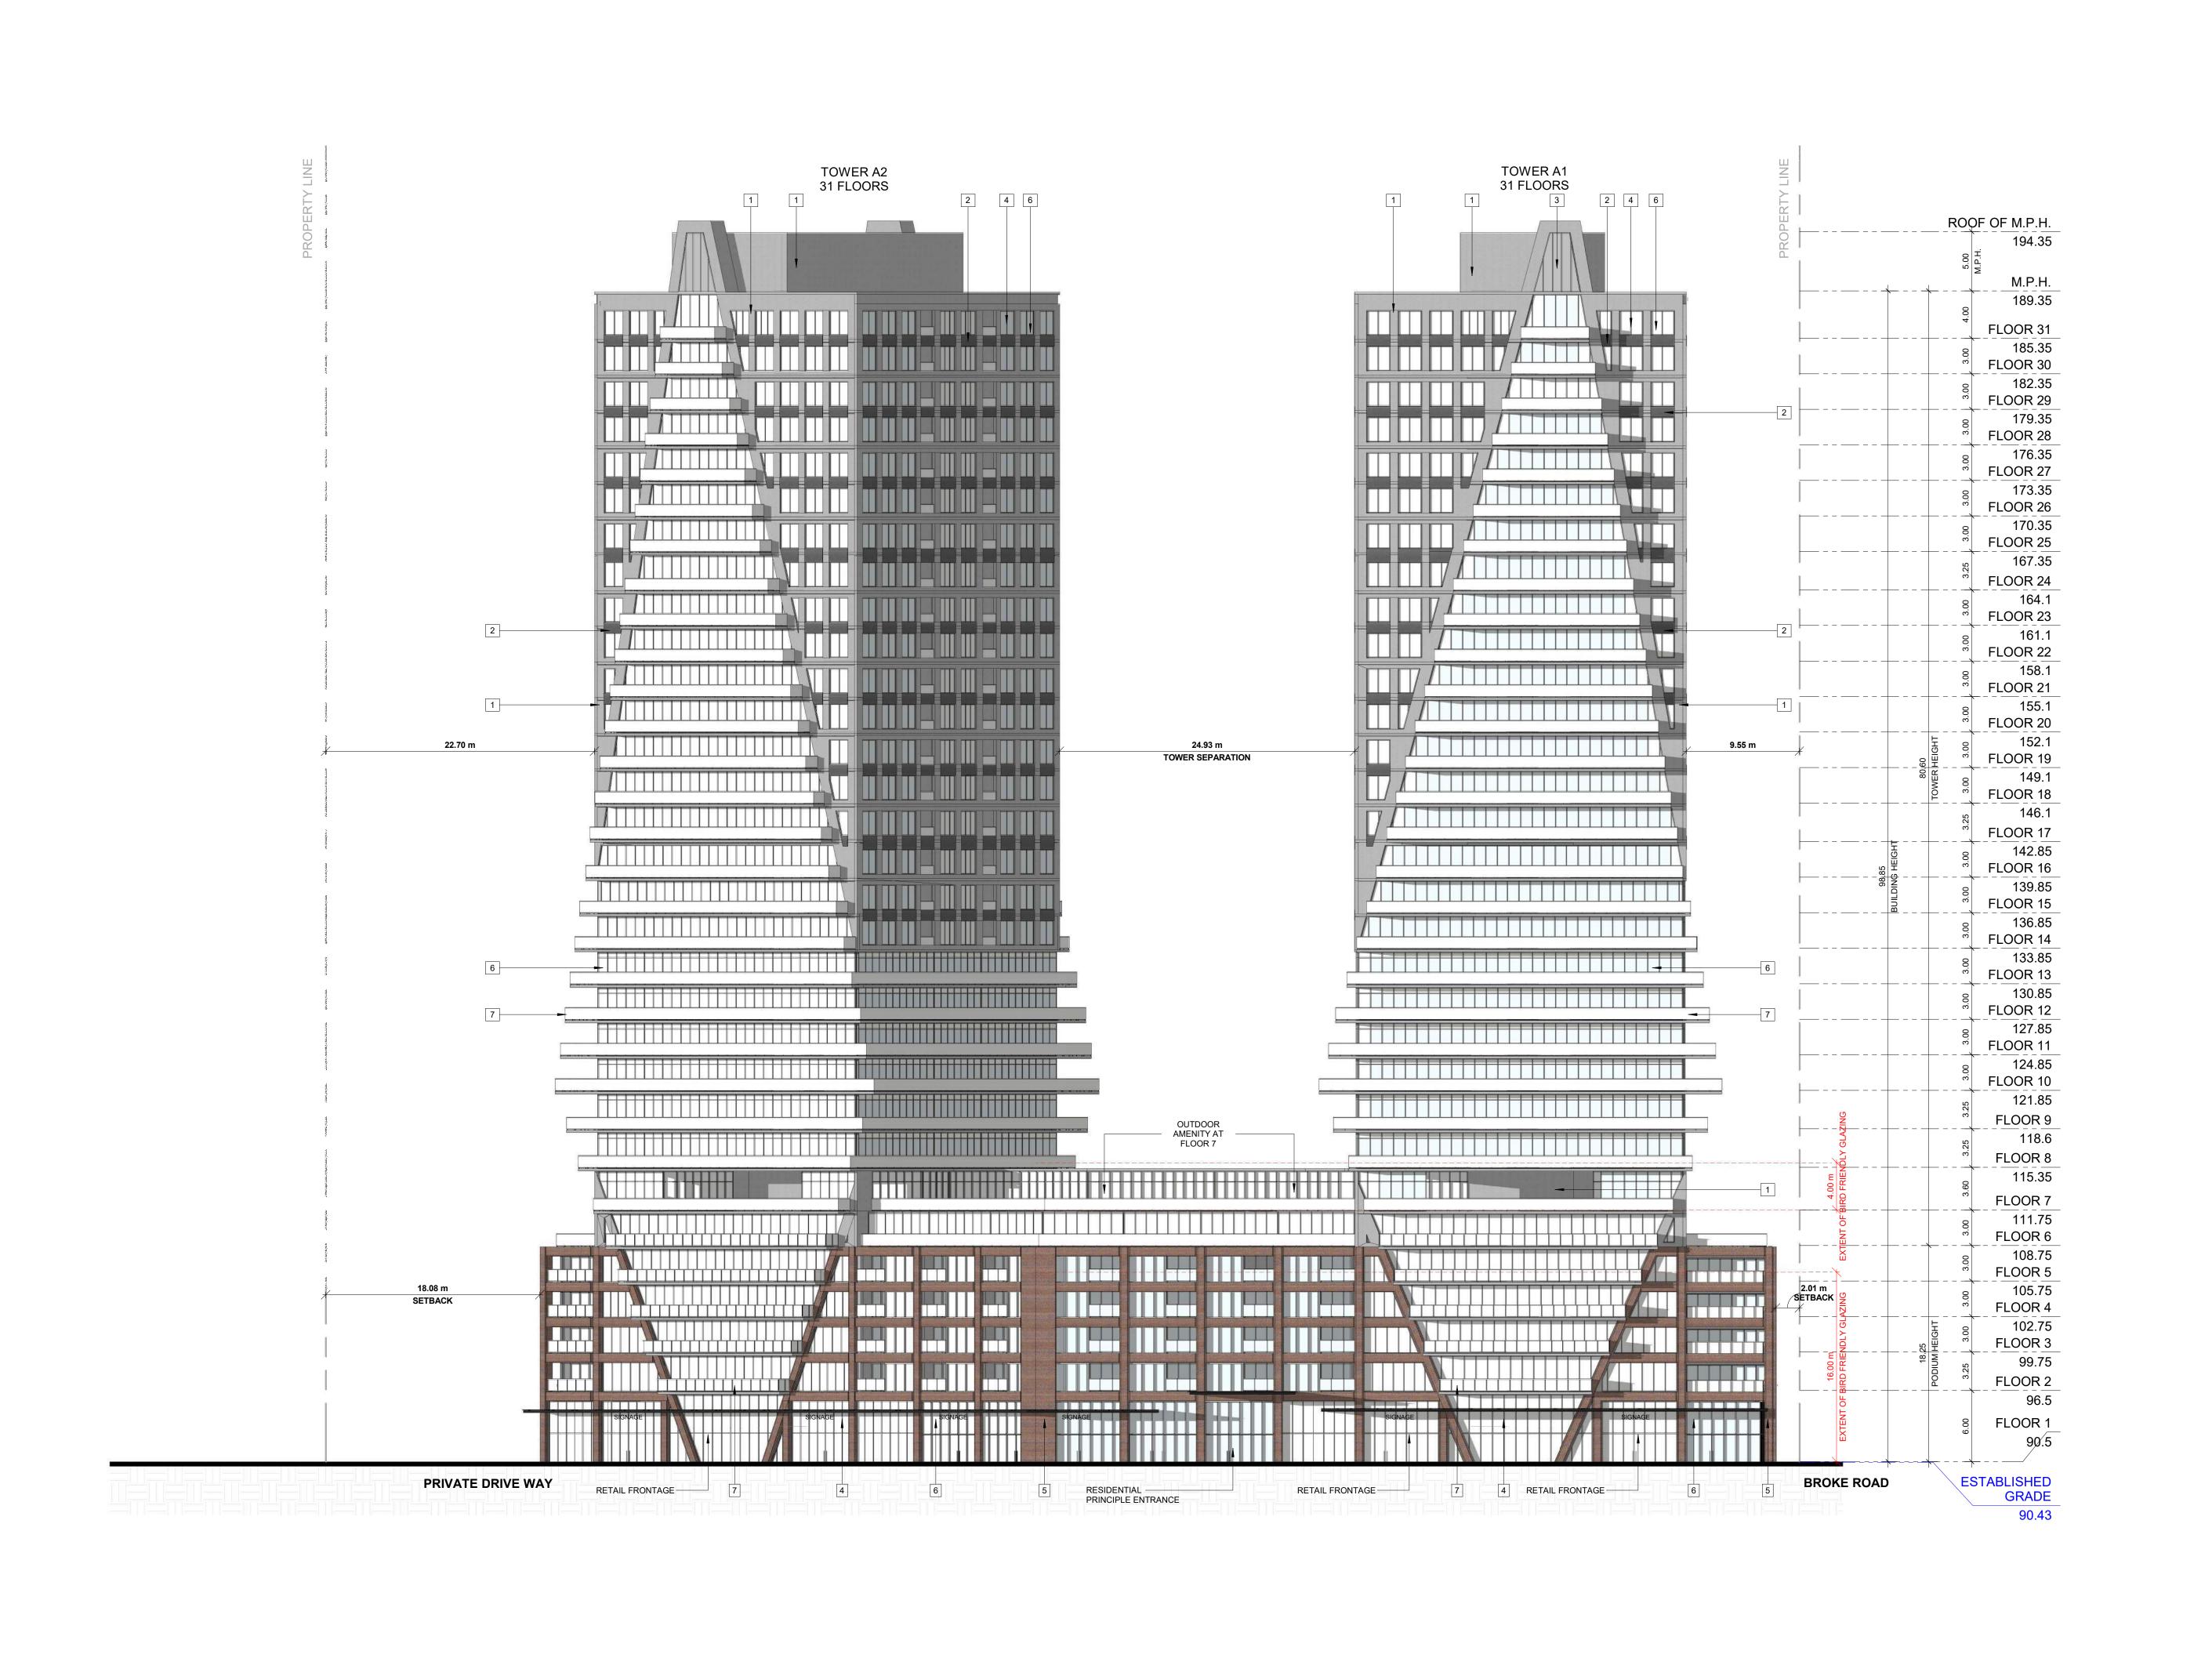

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EXTERIOR FINISH LEGEND

- 1 PRECAST CONCRETE LIGHT GREY
- PRECAST CONCRETE DARK GREY
- 3 | SPANDREL PANEL DARK GREY
- 4 ALLUMINUM MULLION GREY
- 5 MASONRY DARK RED
- 6 CLEAR GLAZING
- 7 BALCONY GLAZING



DESCRIPTION

PICKERING DESIGN CENTRE (BLOCK 1)

1775 PICKERING PARKWAY PICKERING, ON.

DATE


NORTH ELEVATION

PROJECT NO. 06.037RZ PROJECT DATE 2022-05-12 DRAWN BY TKA

AYU

SCALE

CHECKED BY SSELL L,FLEISCHER LICENCE As indicated

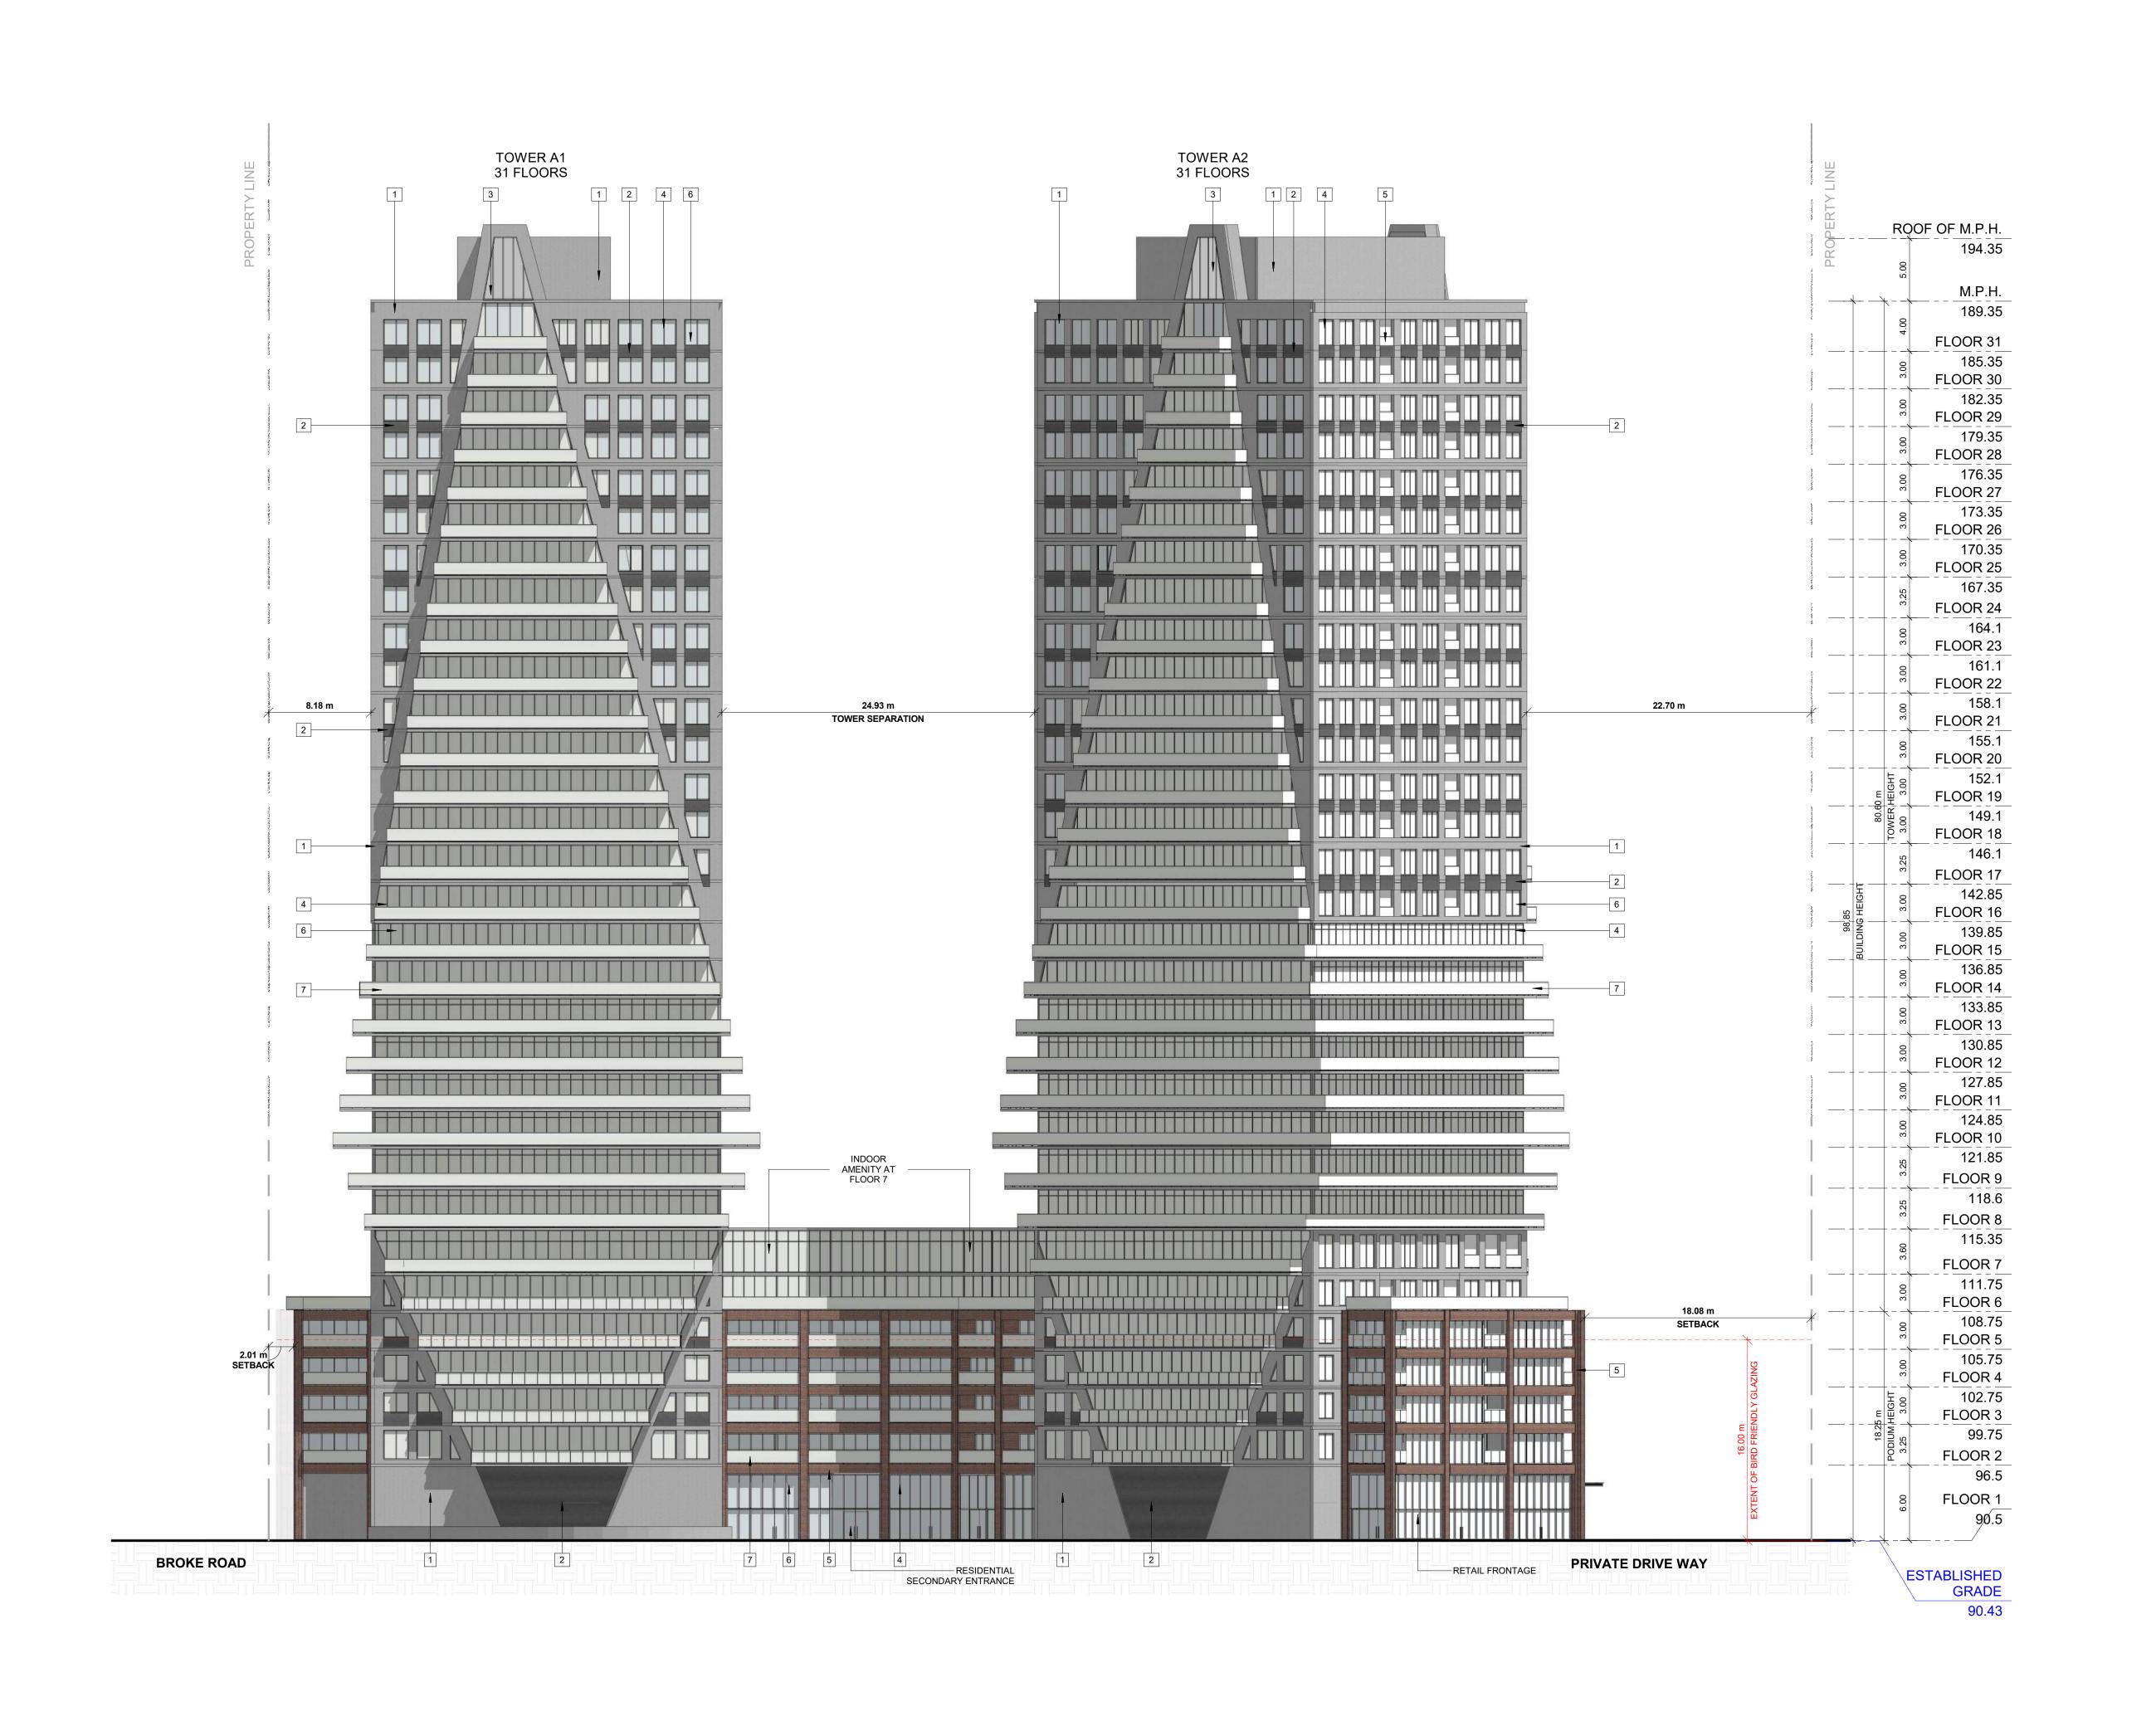

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EXTERIOR FINISH LEGEND

- PRECAST CONCRETE LIGHT GREY
- 2 PRECAST CONCRETE DARK GREY
- 3 SPANDREL PANEL DARK GREY
- 4 ALLUMINUM MULLION GREY
- 5 MASONRY DARK RED
- 0.545.0.470.0
- 6 CLEAR GLAZING

7 BALCONY GLAZING

DATE DESCRIPTION



PICKERING DESIGN CENTRE (BLOCK 1)

1775 PICKERING PARKWAY PICKERING, ON.

SOUTH ELEVATION

PROJECT NO.
06.037RZ
PROJECT DATE
2022-05-12

DRAWN BY
TKA
CHECKED BY
AYU
SCALE

As indicated


ARCHITECTS Z

ARCHITECTS Z

LICENCE

LICENCE

5004

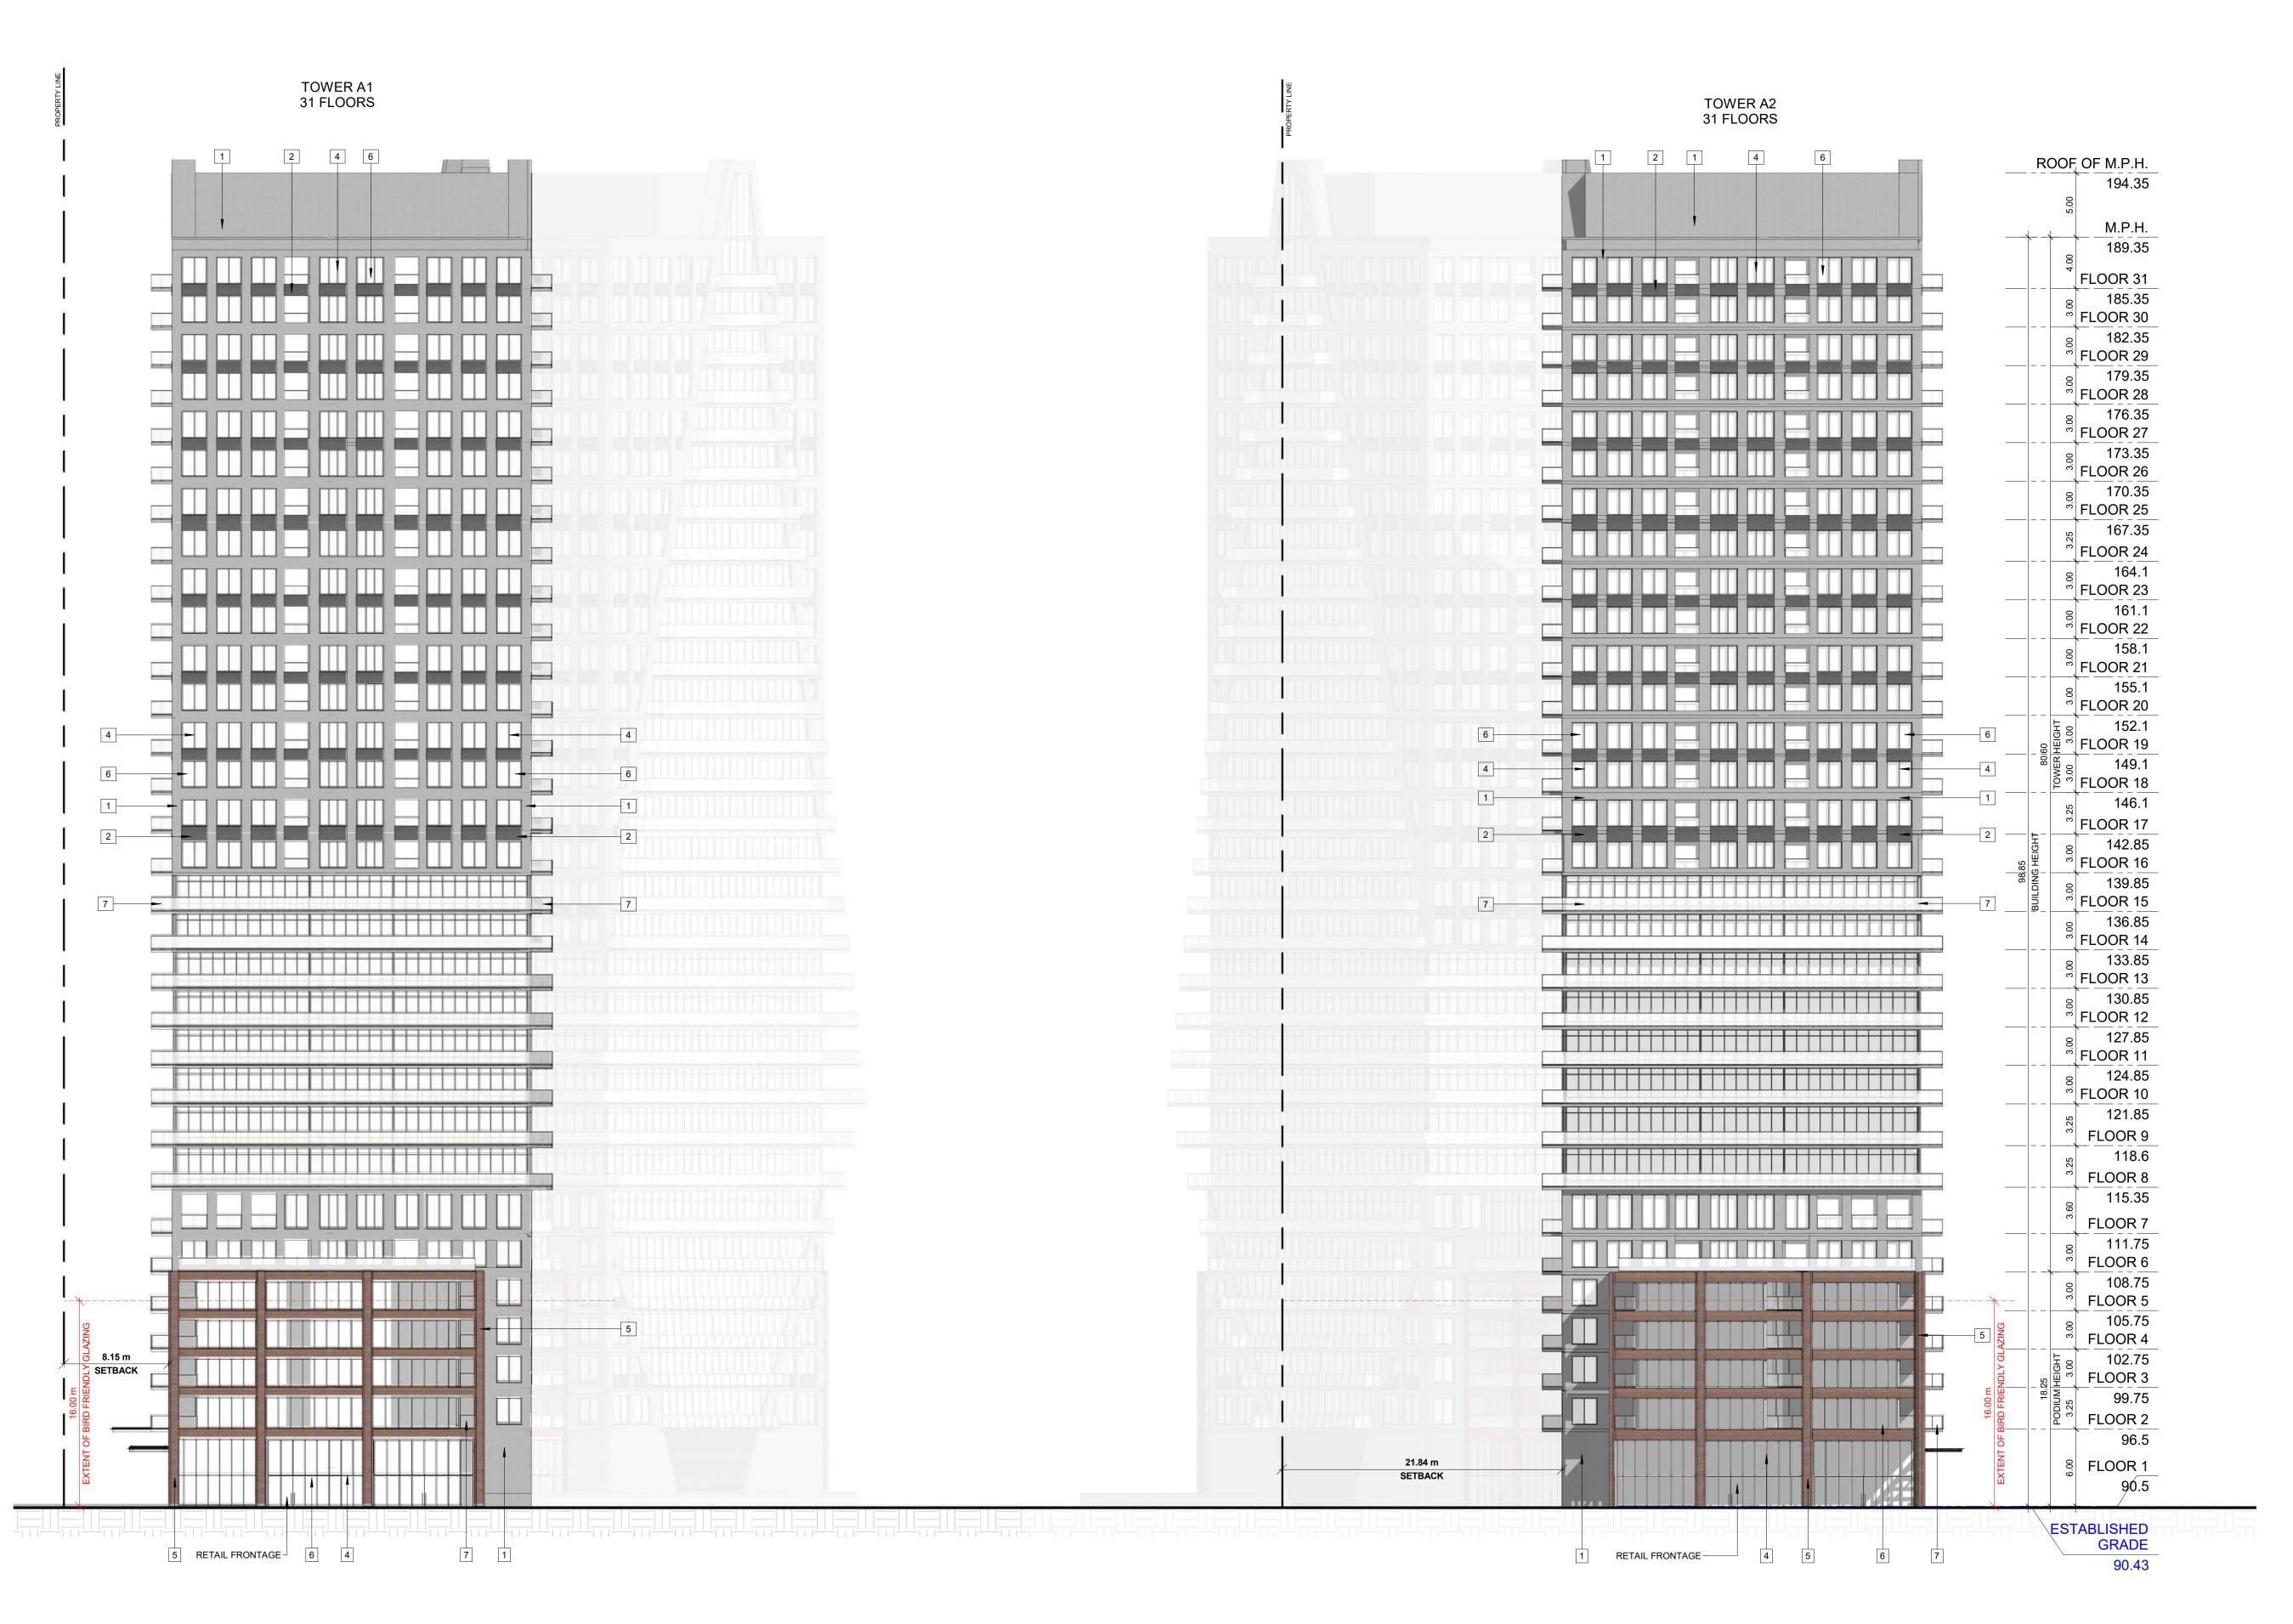

2 West Elevation

SPA303 1 : 250

TURNER FLEISCHER

> 67 Lesmill Road Toronto, ON, M3B 2T8 T 416 425 2222

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EXTERIOR FINISH LEGEND

1 PRECAST CONCRETE - LIGHT GREY

PRECAST CONCRETE - DARK GREY

3 SPANDREL PANEL - DARK GREY

4 ALLUMINUM MULLION - GREY 5 MASONRY - DARK RED

6 CLEAR GLAZING

7 BALCONY GLAZING

DATE DESCRIPTION



PICKERING DESIGN CENTRE (BLOCK 1)

1775 PICKERING PARKWAY PICKERING, ON.

EAST AND WEST ELEVATIONS


PROJECT NO. 06.037RZ PROJECT DATE 2022-05-12 DRAWN BY TKA CHECKED BY

AYU SCALE


SSELL L,FLEISCHER LICENCE As indicated

SPA303

1 South East Elevation SPA303 1 : 250

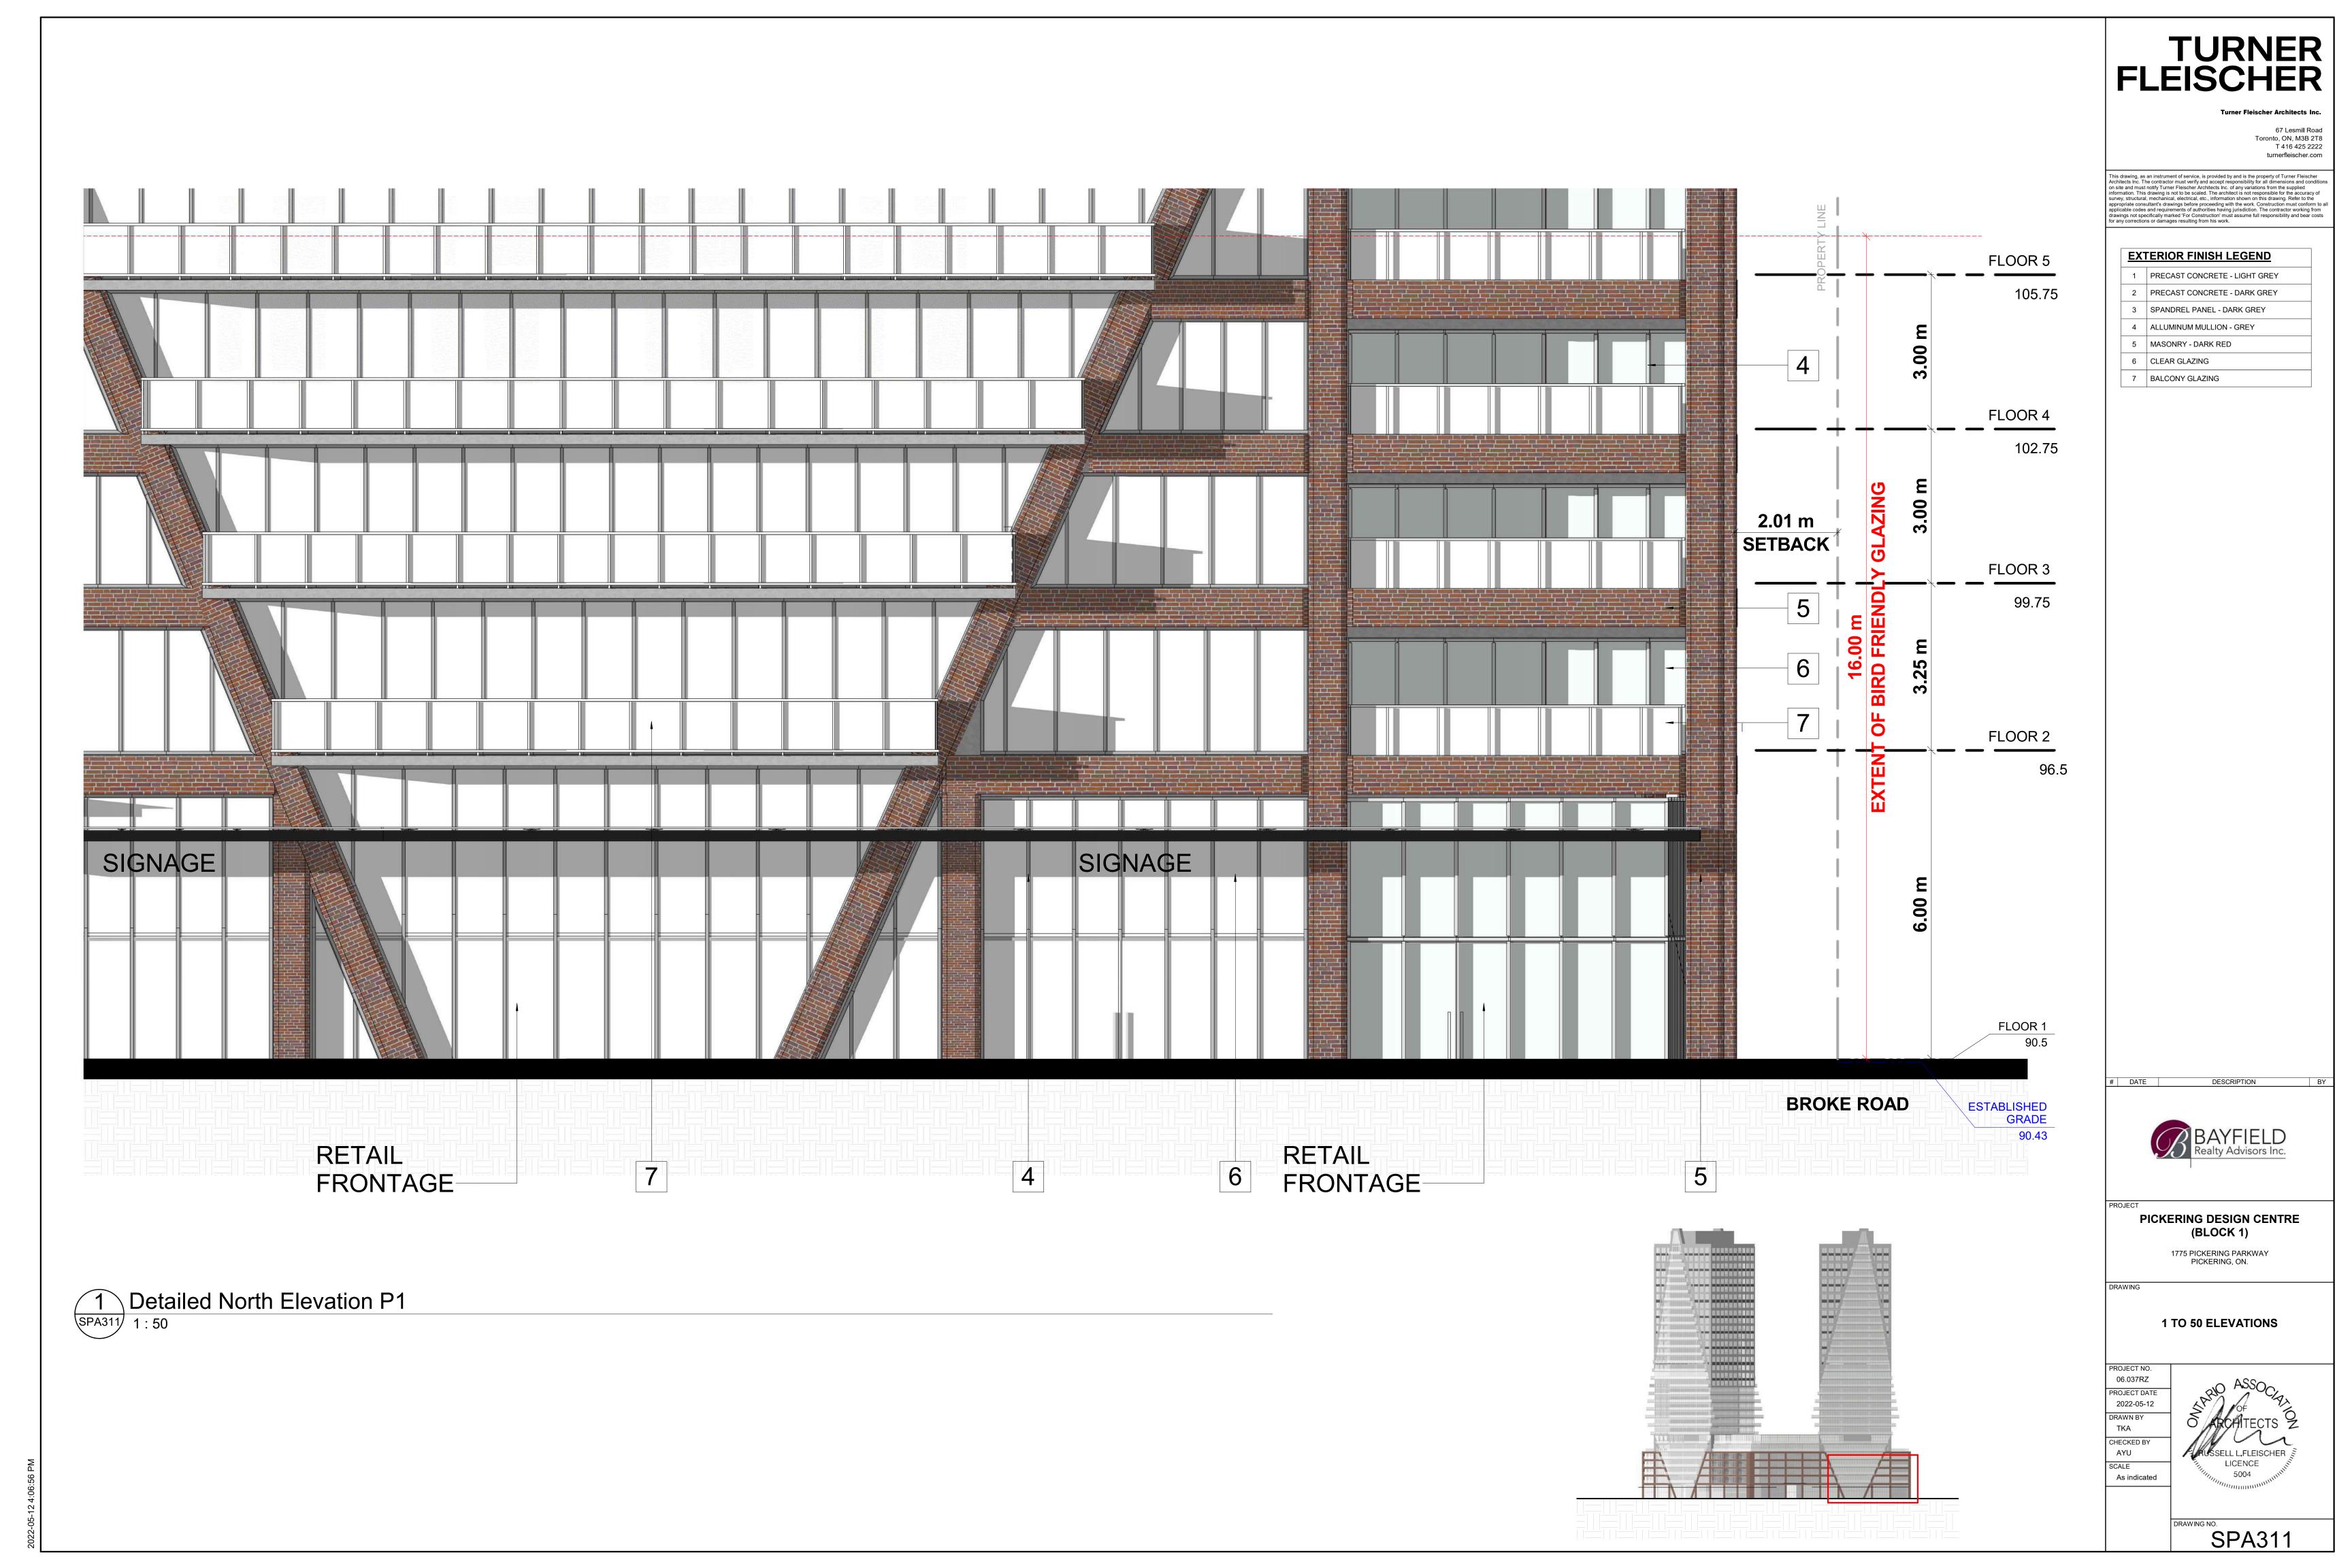



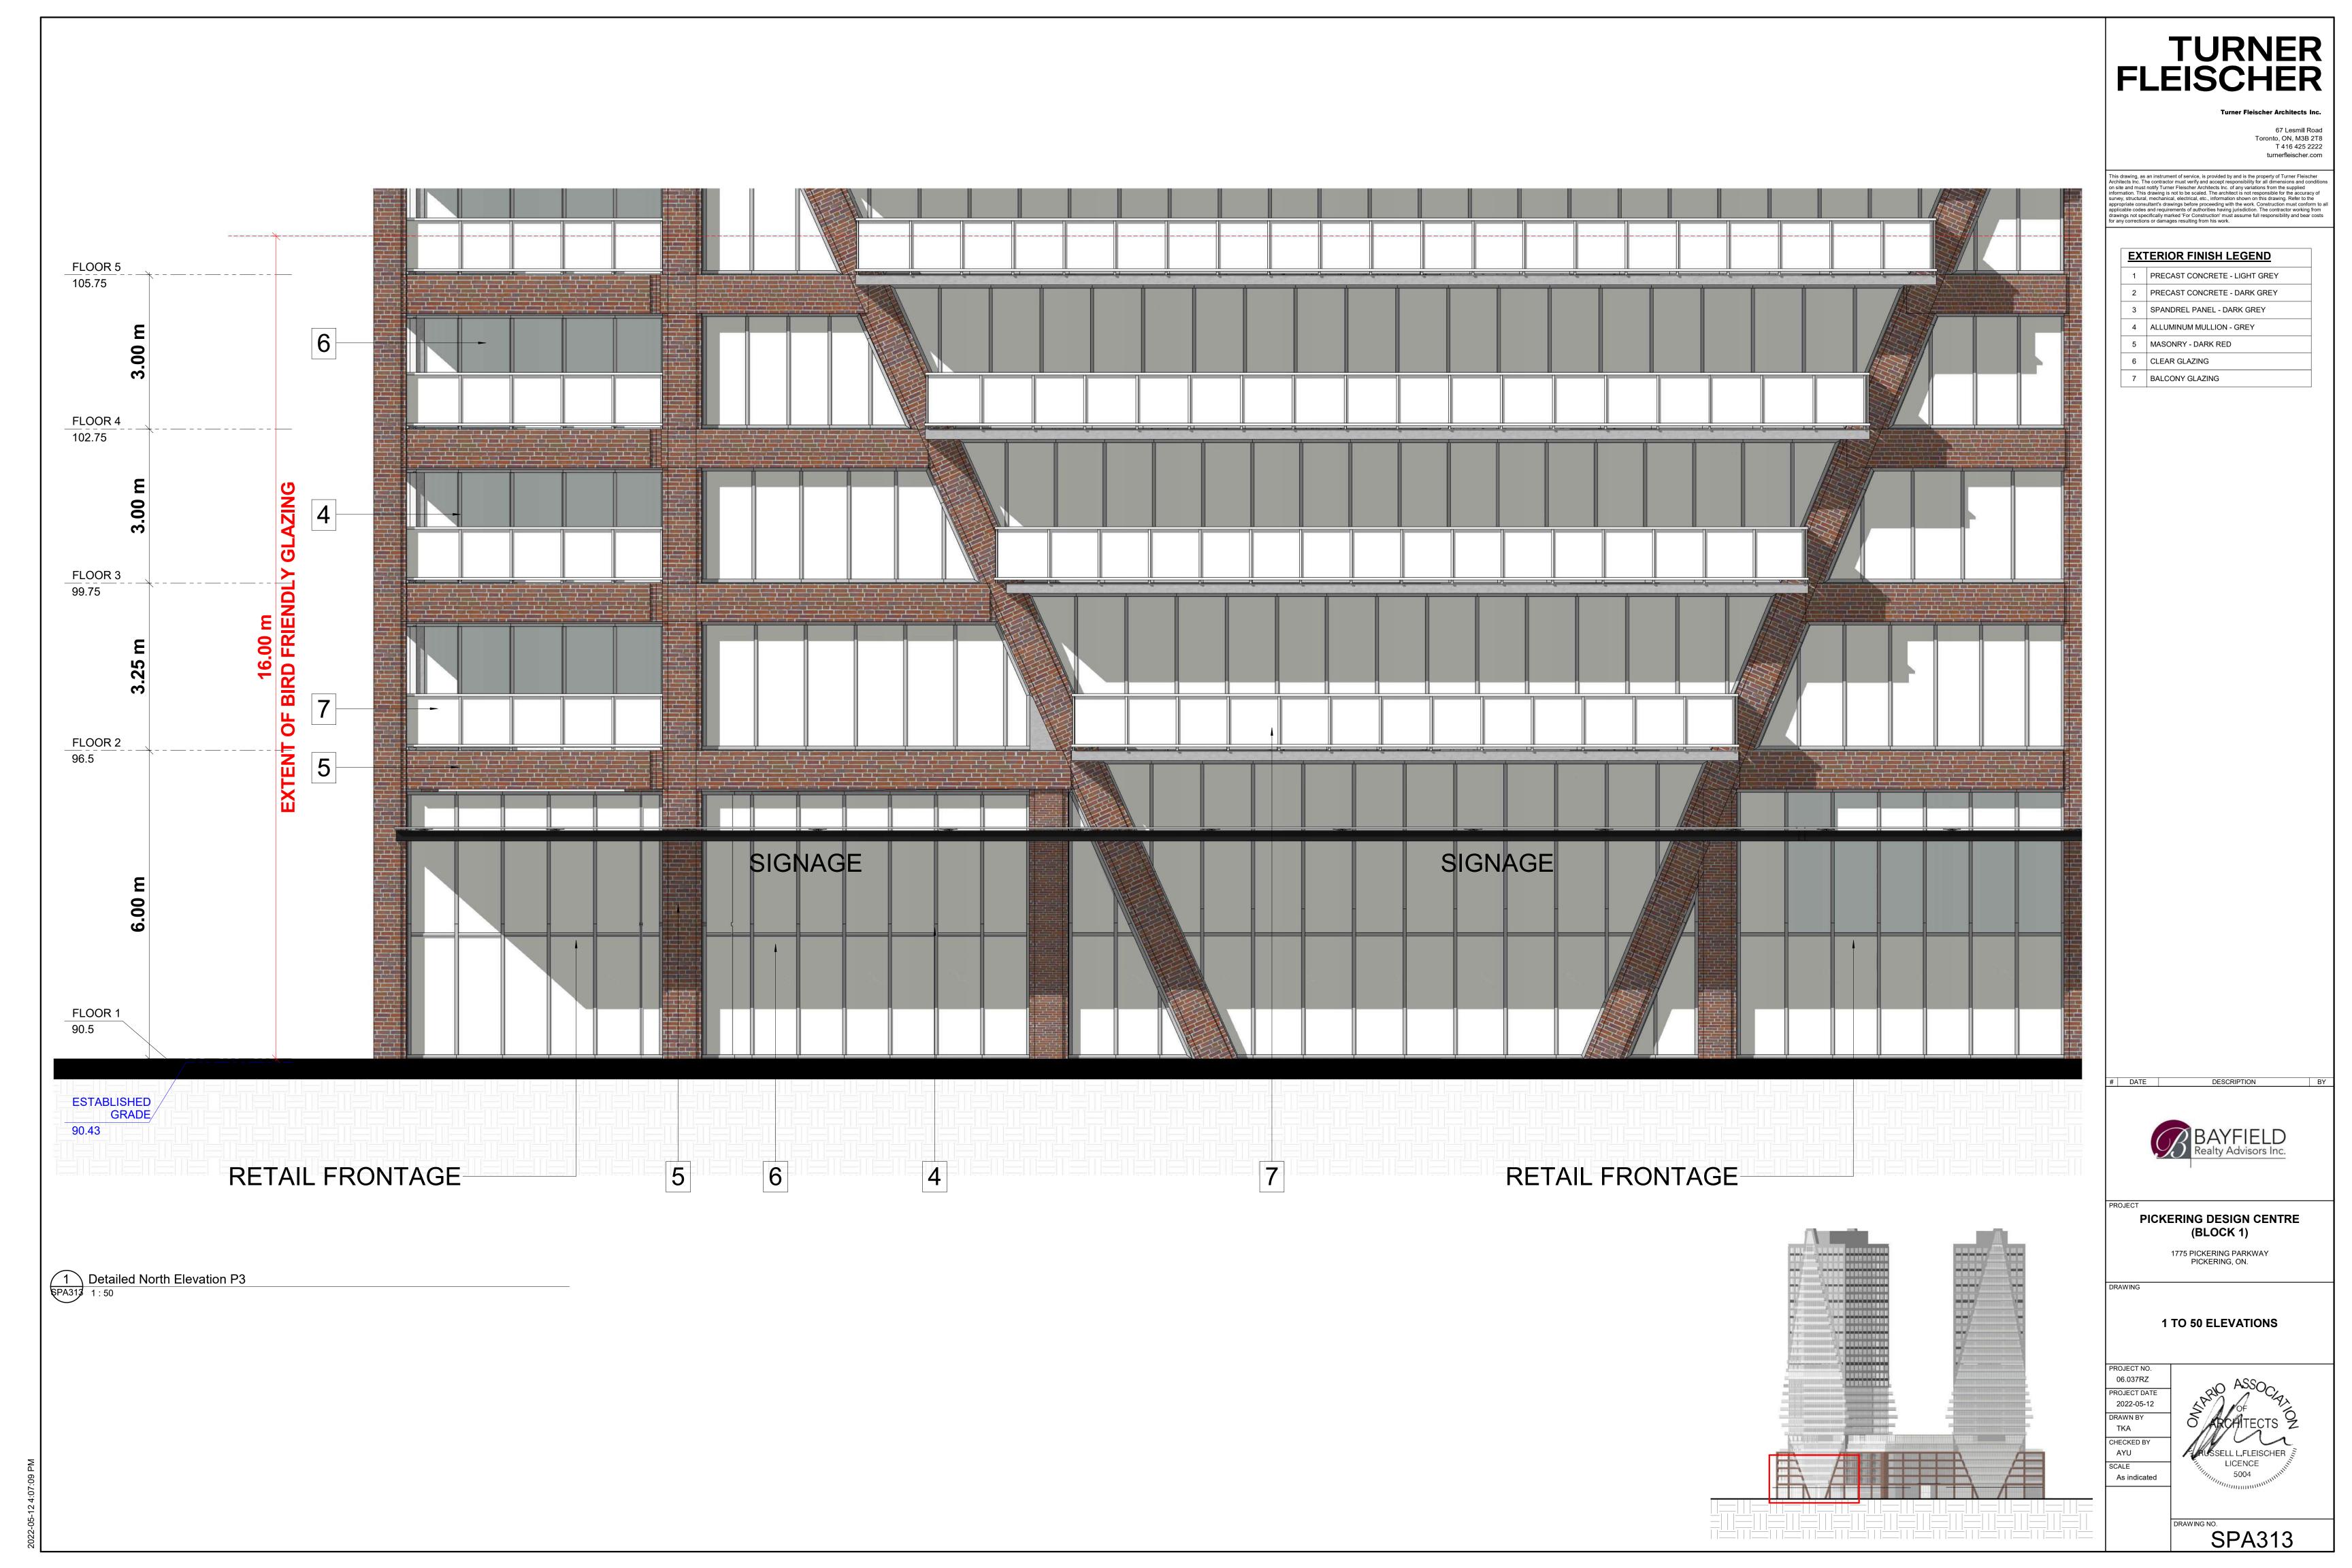





67 Lesmill Road Toronto, ON, M3B 2T8 T 416 425 2222

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EXTERIOR FINISH LEGEND

1 PRECAST CONCRETE - LIGHT GREY

2 PRECAST CONCRETE - DARK GREY

3 SPANDREL PANEL - DARK GREY 4 ALLUMINUM MULLION - GREY

5 MASONRY - DARK RED

6 CLEAR GLAZING

7 BALCONY GLAZING

DATE DESCRIPTION



PICKERING DESIGN CENTRE (BLOCK 1)

1775 PICKERING PARKWAY PICKERING, ON.

1 TO 50 ELEVATIONS

PROJECT NO. 06.037RZ PROJECT DATE 2022-05-12 DRAWN BY

SSELL L,FLEISCHER LICENCE As indicated

1775 PICKERING PARKWAY, PICKERING, ON

BIRD FRIENDLY DIAGRAM

1. Solid / Opaque Surfaces

On the EAST ELEVATION, 457.7 m2 is located within the bird-friendly zone. Of this total surface area, 203.9 m2 or 44.6% are opaque surfaces such as precast, brick, metal panel, and aluminum.

On the WEST ELEVATION, 450.7 m2 is located within the bird-friendly zone. Of this total surface area, 203.2 m2 or 45.1% are opaque surfaces such as precast, brick, metal panel, and aluminum.

On the NORTH ELEVATION P1, 1200.5 m2 is located within the bird-friendly zone. Of this total surface area, 444.8 m2 or 37.0% are opaque surfaces such as precast, brick, metal panel, and aluminum.

On the NORTH ELEVATION P2, 1034.5 m2 is located within the bird-friendly zone. Of this total surface area, 397.8 m2 or 38.5% are opaque surfaces such as precast, brick, metal panel, and aluminum.

On the EAST ELEVATION, 253.7 m2 of glazed surfaces is located within the bird friendly zone. Of these glazed surfaces 2.0% is shaded from balcony and canopy overhangs, 0.0% is spandrel glass, 96.4% is vision glass with a frit pattern and 0.0% is vision glass with no treatment. As such, 0.0% of all glazed surfaces are left untreated.

A breakdown of these areas are shown in the chart:

On the WEST ELEVATION, 247.5 m2 of glazed surfaces is located within the bird friendly zone. Of these glazed surfaces 0.0% is shaded from balcony and canopy overhangs, 0.0% is spandrel glass, 100.0% is vision glass with a frit pattern and 0.0% is vision glass with no treatment. As such, 0.0% of all glazed surfaces are left untreated.

A breakdown of these areas are shown in the chart:

On the NORTH ELEVATION P1, 755.7 m2 of glazed surfaces is located within the bird friendly zone. Of these glazed surfaces 7.7% is shaded from balcony and canopy overhangs, 0.0% is spandrel glass, 92.3% is vision glass with a frit pattern and 0.0% is vision glass with no treatment. As such, 0.0% of all glazed surfaces are left untreated.

A breakdown of these areas are shown in the chart:

On the NORTH ELEVATION P2, 636.7 m2 of glazed surfaces is located within the bird friendly zone. Of these glazed surfaces 19.3% is shaded from balcony and canopy overhangs, 0.0% is spandrel glass, 80.7% is vision glass with a frit pattern and 0.0% is vision glass with no treatment. As such, 0.0% of all glazed surfaces are left untreated.

A breakdown of these areas are shown in the chart:

Frit with a pattern which meets the requirements of the City of Toronto 'Bird Friendly Guidelines' will be used.

06.037 PICKERING DESIGN CENTRE, PICKERING, ON

PICKERING, ONTARIO

PROJECT SUMMARY

REVISED: 2022-04-08

SPA321/ 1


BIRD FRIENDLY ELEVATION CHART


SURFACE Opaque Surfaces - Precast/Metal Panel/Aluminum Glazed Surfaces with Frit Pattern Glazed Surfaces with Shading Glazed Surfaces - Spandrel Glass Glazed Surfaces (Untreated)	AREA (m2)	% OF TOTAL VERTICAL SURFACE	% FOR TREATMENTS OF
Opaque Surfaces - Precast/Metal Panel/Aluminum	203.9	44.6%	N/A
Glazed Surfaces with Frit Pattern	244.685	53.5%	96.4%
Glazed Surfaces with Shading	9.03	2.0%	3.6%
Glazed Surfaces - Spandrel Glass	0.0	0.0%	0.0%
Glazed Surfaces (Untreated)	0.0	0.0%	0.0%
TOTAL	457.7	100%	100%
Total Glazed Surfaces	253.7		

SURFACE	AREA (m2)	% OF TOTAL VERTICAL SURFACE	% FOR TREATMENTS OF
Opaque Surfaces - Precast/Metal Panel/Aluminum	203.2	45.1%	N/A
Glazed Surfaces with Frit Pattern	247.5	54.9%	100.0%
Glazed Surfaces with Shading	0.0	0.0%	0.0%
Glazed Surfaces - Spandrel Glass	0.0	0.0%	0.0%
Glazed Surfaces (Untreated)	0.0	0.0%	0.0%
TOTAL	450.7	100%	100%
Total Glazed Surfaces	247.5		


Г	SURFACE	AREA	% OF TOTAL	% FOR
٥,	JONFACE	(m2)	VERTICAL SURFACE	TREATMENTS OF
<u> </u>	Opaque Surfaces - Precast/Metal Panel/Aluminum	444.8	37.0%	N/A
⊡ [Glazed Surfaces with Frit Pattern	697.7	58.1%	92.3%
$\overline{\mathbf{q}}$	Glazed Surfaces with Shading	58.0	4.8%	7.7%
ELEV	Opaque Surfaces - Precast/Metal Panel/Aluminum Glazed Surfaces with Frit Pattern Glazed Surfaces with Shading Glazed Surfaces - Spandrel Glass	0.0	0.0%	0.0%
NOKIH	Glazed Surfaces (Untreated)	0.0	0.0%	0.0%
	TOTAL	1200.5	100%	100%
-	Total Glazed Surfaces	755.7		

SURFACE	AREA (m2)	% OF TOTAL VERTICAL SURFACE	% FOR TREATMENTS OF
Opaque Surfaces - Precast/Metal Panel/Aluminum	397.8	38.5%	N/A
Glazed Surfaces with Frit Pattern	513.8	49.7%	80.7%
吕 Glazed Surfaces with Shading	122.9	11.9%	19.3%
	0.0	0.0%	0.0%
Glazed Surfaces (Untreated)	0.0	0.0%	0.0%
TOTAL	1034.5	100%	100%
Total Glazed Surfaces	636.7		

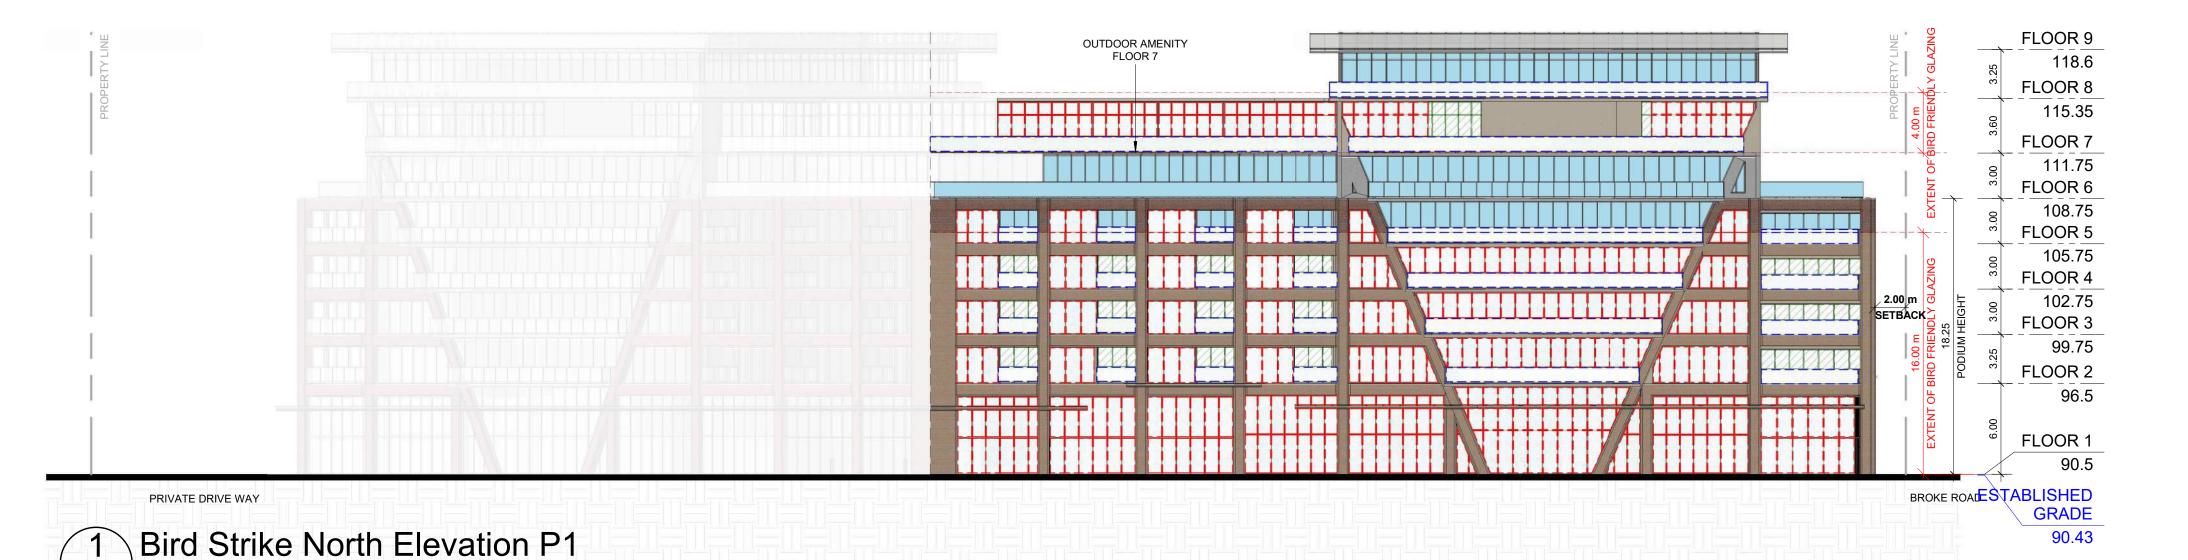


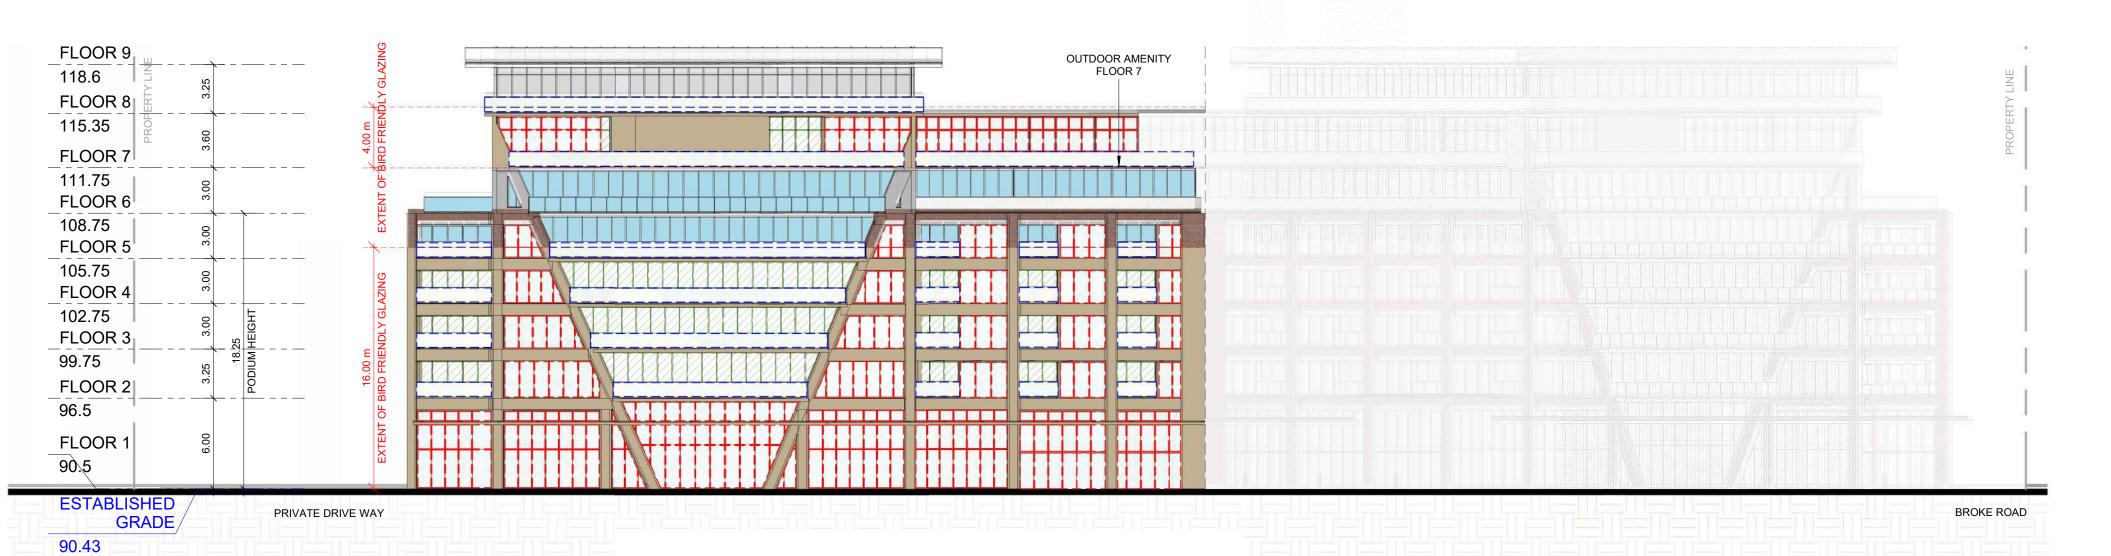

Bird Strike North Elevation P2 SPA321 1:250

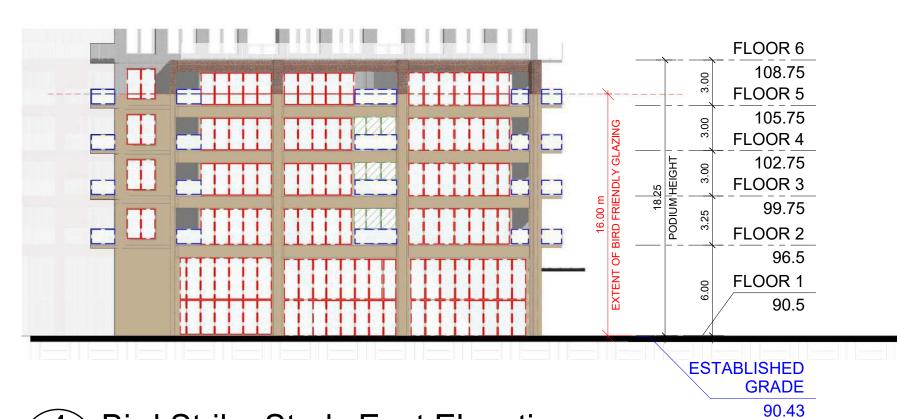

Bird Strike Study East Elevation SPA321 1:250

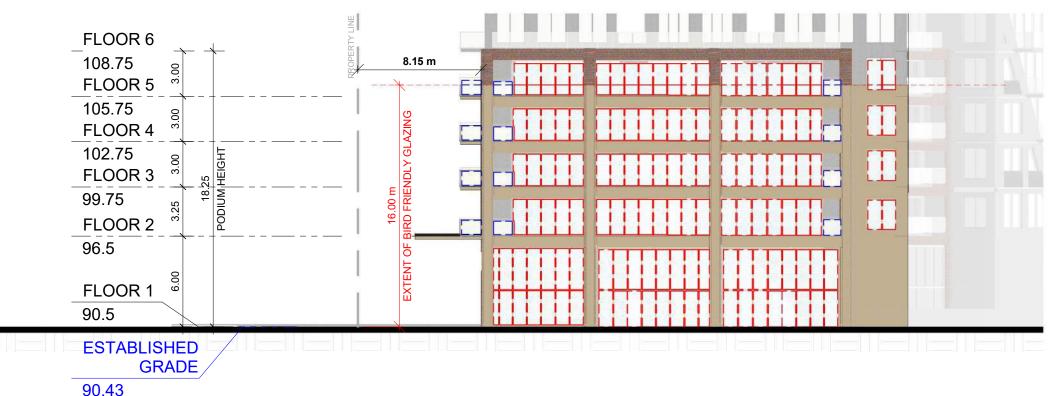

\ Bird Strike Study West Elevation

SPA321 1 : 250

TURNER FLEISCHER

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> GLAZED SURFACES TREATED WITH FRIT PATTERN AS PER THE FRIT PATTERN DETAIL

GLAZED BALCONIES TREATED WITH FRIT PATTERN AS PER THE FRIT PATTERN DETAIL

GLAZED SURFACES SHADED BY PROJECTION / OVERHANGS

GLAZED SURFACES VISION GLASS (UNTREATED)

OPAQUE SURFACES SUCH AS PRECAST BRICK, METAL PANEL AND ALUMINUM

BIRD FRIENDLY GUIDELINE

GENERAL NOTES IN ACCORDANCE WITH THE BIRD-FRIENDLY DEVELOPMENT GUIDELINES (FIRST 16 METERS ABOVE GRADE AND 4 METERS ABOVE GREEN FEATURE):

PROVISION OF VISUAL MARKERS
- VISUAL MARKERS TO ALERT BIRDS WILL BE PROVIDED. INCREASING THE SOLID TO GLASS RATIO OF GLAZING BY PROVIDING A TIGHTER GLAZING GRID IS ONE METHOD CONSIDERED, OTHERS ARE:


- APPLICATION OF FILM AND DECALS TO THE -MUTTING REFECTIONS IN THE GLASS THROUGH THE USE OF INTERNAL SCREENS PLACED CLOSE TO THE GLASS SURFACE. - CANOPIES LOCATED ALONG THE BUILDING

FACADE TO PROVIDE ADDITIONAL MUTING

OF REFLECTED IMAGES - USE PANEL GLASS TREATED WITH A PATTERN FROM AGC FOR ALL VISION GLASS ON LEVEL 1 & 2

REDUCTION OF LIGHT POLLUTION - REDUCTION OF LIGHT POLLUTION FROM INTERIOR LIGHTS, PARTICULARLY DURING MIGRATION PERIODS. - SELECTION OF APPROPRIATE EXTERNAL LIGHTING FIXTURES TO ELIMINATE DIRECT UPWARDS LIGHT. REDUCE SPILL LIGHT AND OPTIMIZE USEFUL LIGHT.

<u>DETAIL NOTE*:</u> FRITTED GLASS WILL BE TREATED WITH A DENSITY PATTERN OF VISUAL MARKERS NO MORE THAN 50mm X 50mm APART FOR THE FIRST 16M ABOVE GRADE. (TORONTO GREEN STANDARD EC4.1)

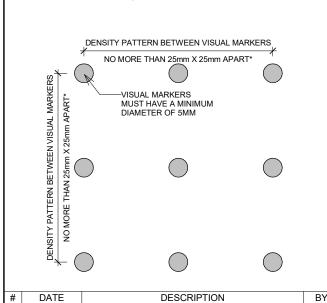

PICKERING DESIGN CENTRE (BLOCK 1)

1775 PICKERING PARKWAY

BIRD STRIKE STUDY

06.037RZ PROJECT DATE 2022-05-12 DRAWN BY TKA CHECKED BY AYU LICENCE SCALE As indicated

1775 PICKERING PARKWAY, PICKERING, ON

BIRD FRIENDLY DIAGRAM

1. Solid / Opaque Surfaces

On the SOUTH ELEVATION P1, 841.9 m2 is located within the bird-friendly zone. Of this total surface area, 435.0 m2 or 51.7% are opaque surfaces such as precast, brick, metal panel, and aluminum.

On the SOUTH ELEVATION P2, 710.9 m2 is located within the bird-friendly zone. Of this total surface area, 401.9 m2 or 56.5% are opaque surfaces such as precast, brick, metal panel, and aluminum.

2. Glass

On the SOUTH ELEVATION P1, 406.9 m2 of glazed surfaces is located within the bird friendly zone. Of these glazed surfaces 35.9% is shaded from balcony and canopy overhangs, 0.0% is spandrel glass, 64.1% is vision glass with a frit pattern and 0.0% is vision glass with no treatment. As such, 0.0% of all glazed surfaces are left untreated.

A breakdown of these areas are shown in the chart:

On the SOUTH ELEVATION P2, 308.9 m2 of glazed surfaces is located within the bird friendly zone. Of these glazed surfaces 38.0% is shaded from balcony and canopy overhangs, 0.0% is spandrel glass, 62.0% is vision glass with a frit pattern and 0.0% is vision glass with no treatment. As such, 0.0% of all glazed surfaces are left untreated.

A breakdown of these areas are shown in the chart:


Frit with a pattern which meets the requirements of the City of Toronto 'Bird Friendly Guidelines' will be used.


P1	SURFACE	AREA	% OF TOTAL	% FOR
O	SURFACE	(m2)	VERTICAL SURFACE	TREATMENTS OF
Ĕ	Opaque Surfaces - Precast/Metal Panel/Aluminum	435.0	51.7%	N/A
\$	Glazed Surfaces with Frit Pattern	260.8	31.0%	64.1%
ELE	Glazed Surfaces with Shading	146.1	17.4%	35.9%
Ξ	Glazed Surfaces - Spandrel Glass	0.0	0.0%	0.0%
5	Glazed Surfaces (Untreated)	0.0	0.0%	0.0%
SO	TOTAL	841.9	100%	100%
	Total Glazed Surfaces	406.9		

SURFACE Opaque Surfaces - Precast/Metal Panel/Aluminum Glazed Surfaces with Frit Pattern Glazed Surfaces with Shading	AREA (m2)	% OF TOTAL VERTICAL SURFACE	% FOR TREATMENTS OF
Opaque Surfaces - Precast/Metal Panel/Aluminum	401.9	56.5%	N/A
Glazed Surfaces with Frit Pattern	191.6	27.0%	62.0%
Glazed Surfaces with Shading	117.3	16.5%	38.0%
Glazed Surfaces - Spandrel Glass	0.0	0.0%	0.0%
Glazed Surfaces (Untreated)	0.0	0.0%	0.0%
Glazed Surfaces - Spandrel Glass Glazed Surfaces (Untreated) TOTAL	710.9	100%	100%
Total Glazed Surfaces	308.9		

	SURFACE	AREA (m2)	% OF TOTAL VERTICAL SURFACE	% FOR TREATMENTS OF
킈	Opaque Surfaces - Precast/Metal Panel/Aluminum	2086.6	44.4%	N/A
1	Glazed Surfaces with Frit Pattern	2156.2	45.9%	82.6%
	Glazed Surfaces with Shading	453.3	9.7%	17.4%
	Glazed Surfaces with Shading Glazed Surfaces - Spandrel Glass	0.0	0.0%	0.0%
-	Glazed Surfaces (Untreated)	0.0	0.0%	0.0%
	TOTAL	4696.1	100%	100%
	Total Glazed Surfaces	2609.5		

Total Glazed Surfaces 7305.6

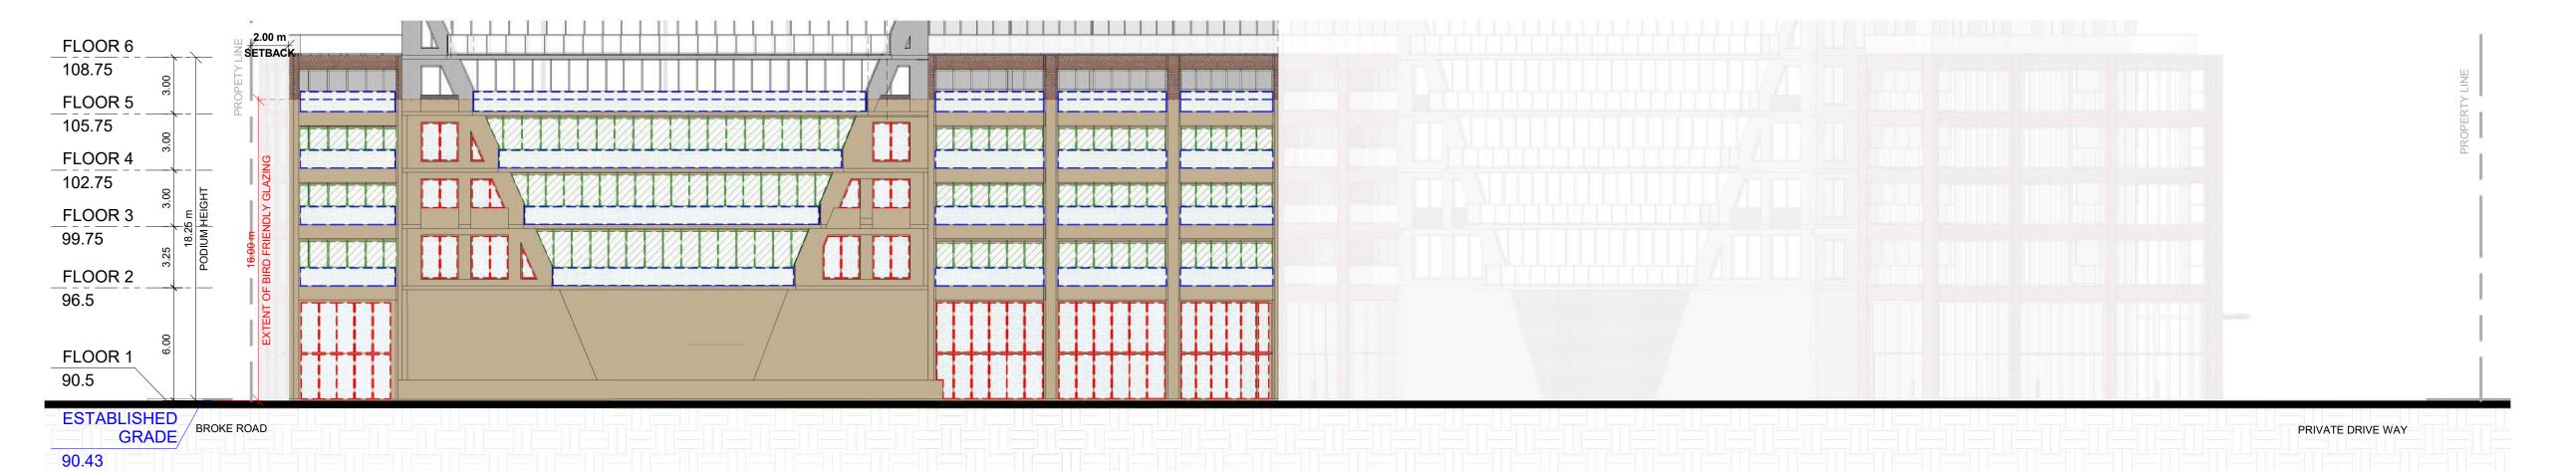

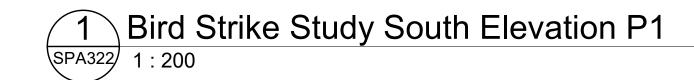



Bird Strike Study South Elevation P2 SPA322 1 : 200

GRADE

TURNER

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Toronto, ON, M3B 2T8 T 416 425 2222

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GLAZED SURFACES TREATED WITH

FRIT PATTERN AS PER THE FRIT PATTERN DETAIL

GLAZED SURFACES

GLAZED BALCONIES TREATED WITH FRIT PATTERN AS PER THE FRIT PATTERN DETAIL

SHADED BY PROJECTION / OVERHANGS GLAZED SURFACES

VISION GLASS (UNTREATED)

OPAQUE SURFACES SUCH AS PRECAST, BRICK, METAL PANEL AND ALUMINUM

BIRD FRIENDLY GUIDELINE

GENERAL NOTES IN ACCORDANCE WITH THE BIRD-FRIENDLY DEVELOPMENT GUIDELINES (FIRST 16 METERS ABOVE GRADE AND 4 METERS ABOVE GREEN FEATURE): PROVISION OF VISUAL MARKERS

- VISUAL MARKERS TO ALERT BIRDS WILL BE PROVIDED. INCREASING THE SOLID TO GLASS RATIO OF GLAZING BY PROVIDING A TIGHTER GLAZING GRID IS ONE METHOD CONSIDERED, OTHERS ARE: - APPLICATION OF FILM AND DECALS TO THE

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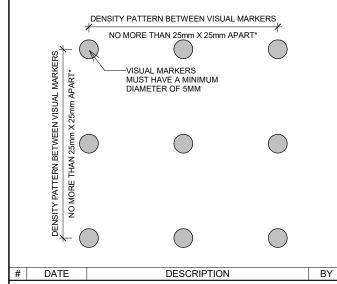
OF REFLECTED IMAGES - USE PANEL GLASS TREATED WITH A PATTERN FROM AGC FOR ALL VISION GLASS ON LEVEL 1 & 2

FACADE TO PROVIDE ADDITIONAL MUTING

REDUCTION OF LIGHT POLLUTION - REDUCTION OF LIGHT POLLUTION FROM INTERIOR LIGHTS, PARTICULARLY DURING MIGRATION PERIODS. - SELECTION OF APPROPRIATE EXTERNAL LIGHTING FIXTURES TO ELIMINATE DIRECT

UPWARDS LIGHT. REDUCE SPILL LIGHT AND OPTIMIZE USEFUL LIGHT.

DETAIL NOTE*:
FRITTED GLASS WILL BE TREATED WITH A DENSITY PATTERN OF VISUAL MARKERS NO MORE THAN 50mm X 50mm APART FOR THE FIRST 16M ABOVE GRADE. (TORONTO GREEN STANDARD EC4.1)




PICKERING DESIGN CENTRE (BLOCK 1)

1775 PICKERING PARKWAY PICKERING, ON.

BIRD STRIKE STUDY

06.037RZ PROJECT DATE 2022-05-12 DRAWN BY TKA CHECKED BY AYU SCALE As indicated

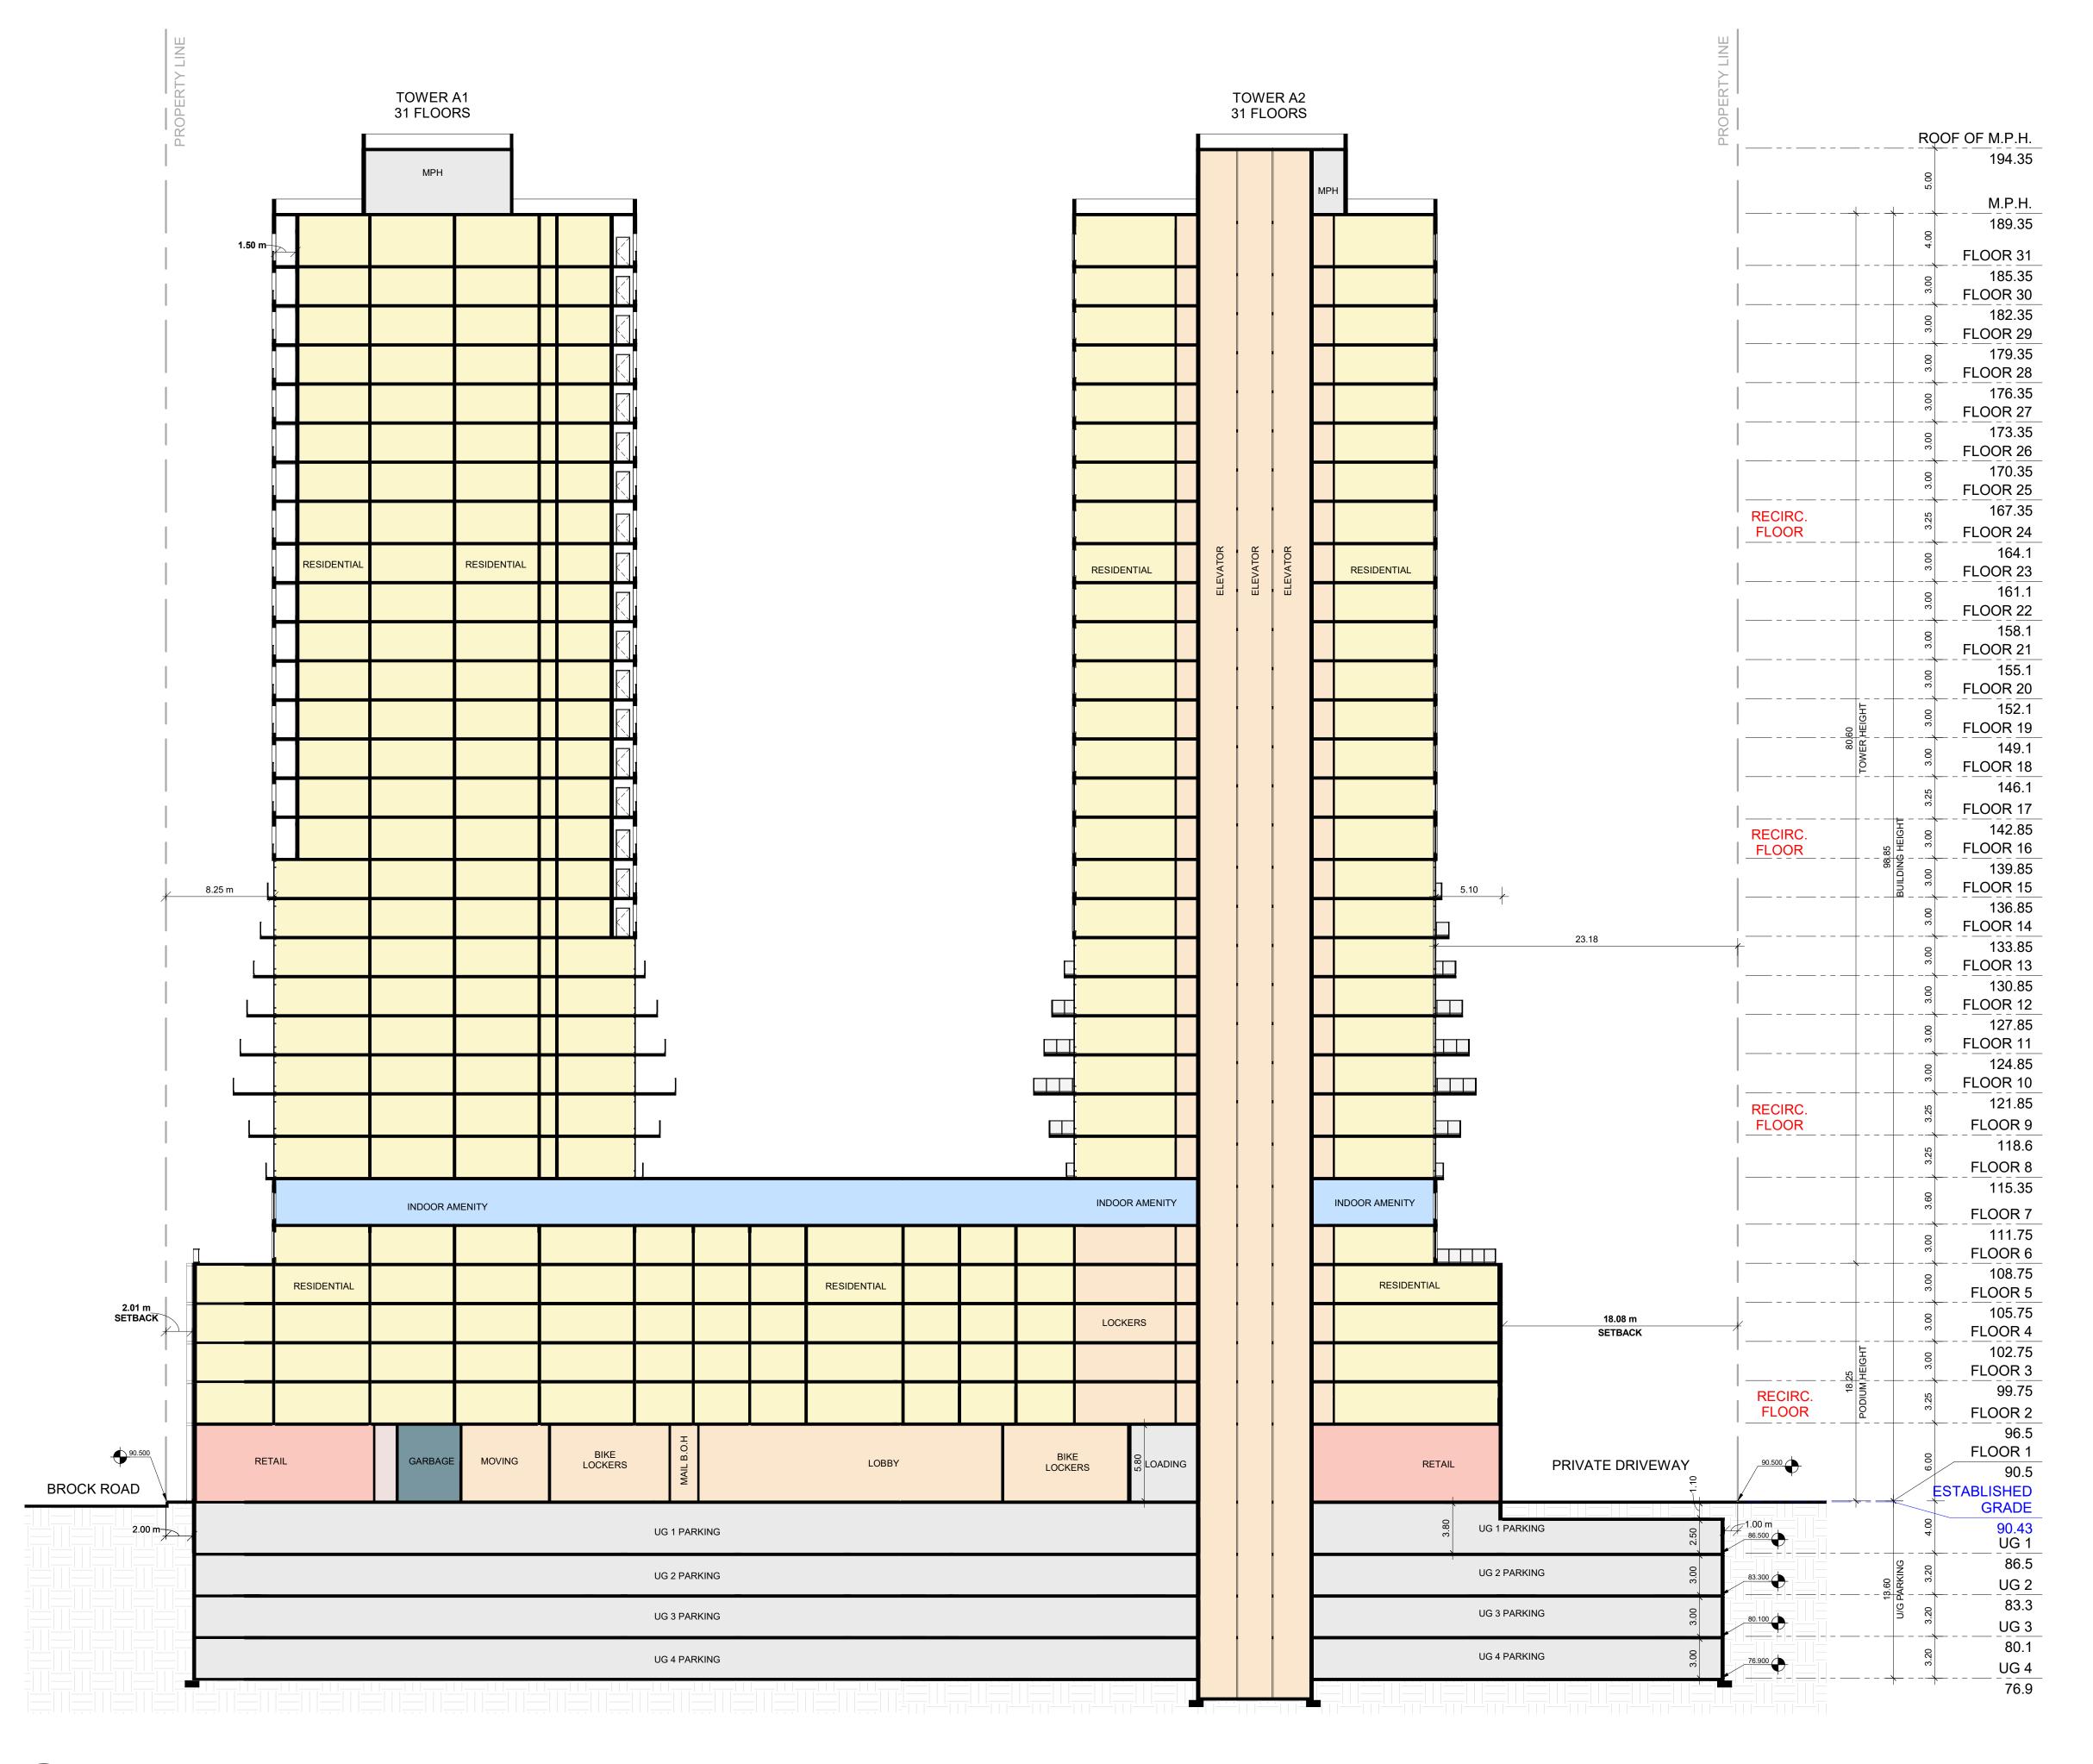

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PROJECT NO.
06.037RZ

PROJECT DATE
2022-05-12

DRAWN BY
TKA

CHECKED BY

AYU SCALE

1:250

ASSOCIATE OF ARCHITECTS

ARCHITECTS


ARCHITECTS

LICENCE

5004

SPA401

A Section A-A SPA401 1 : 250

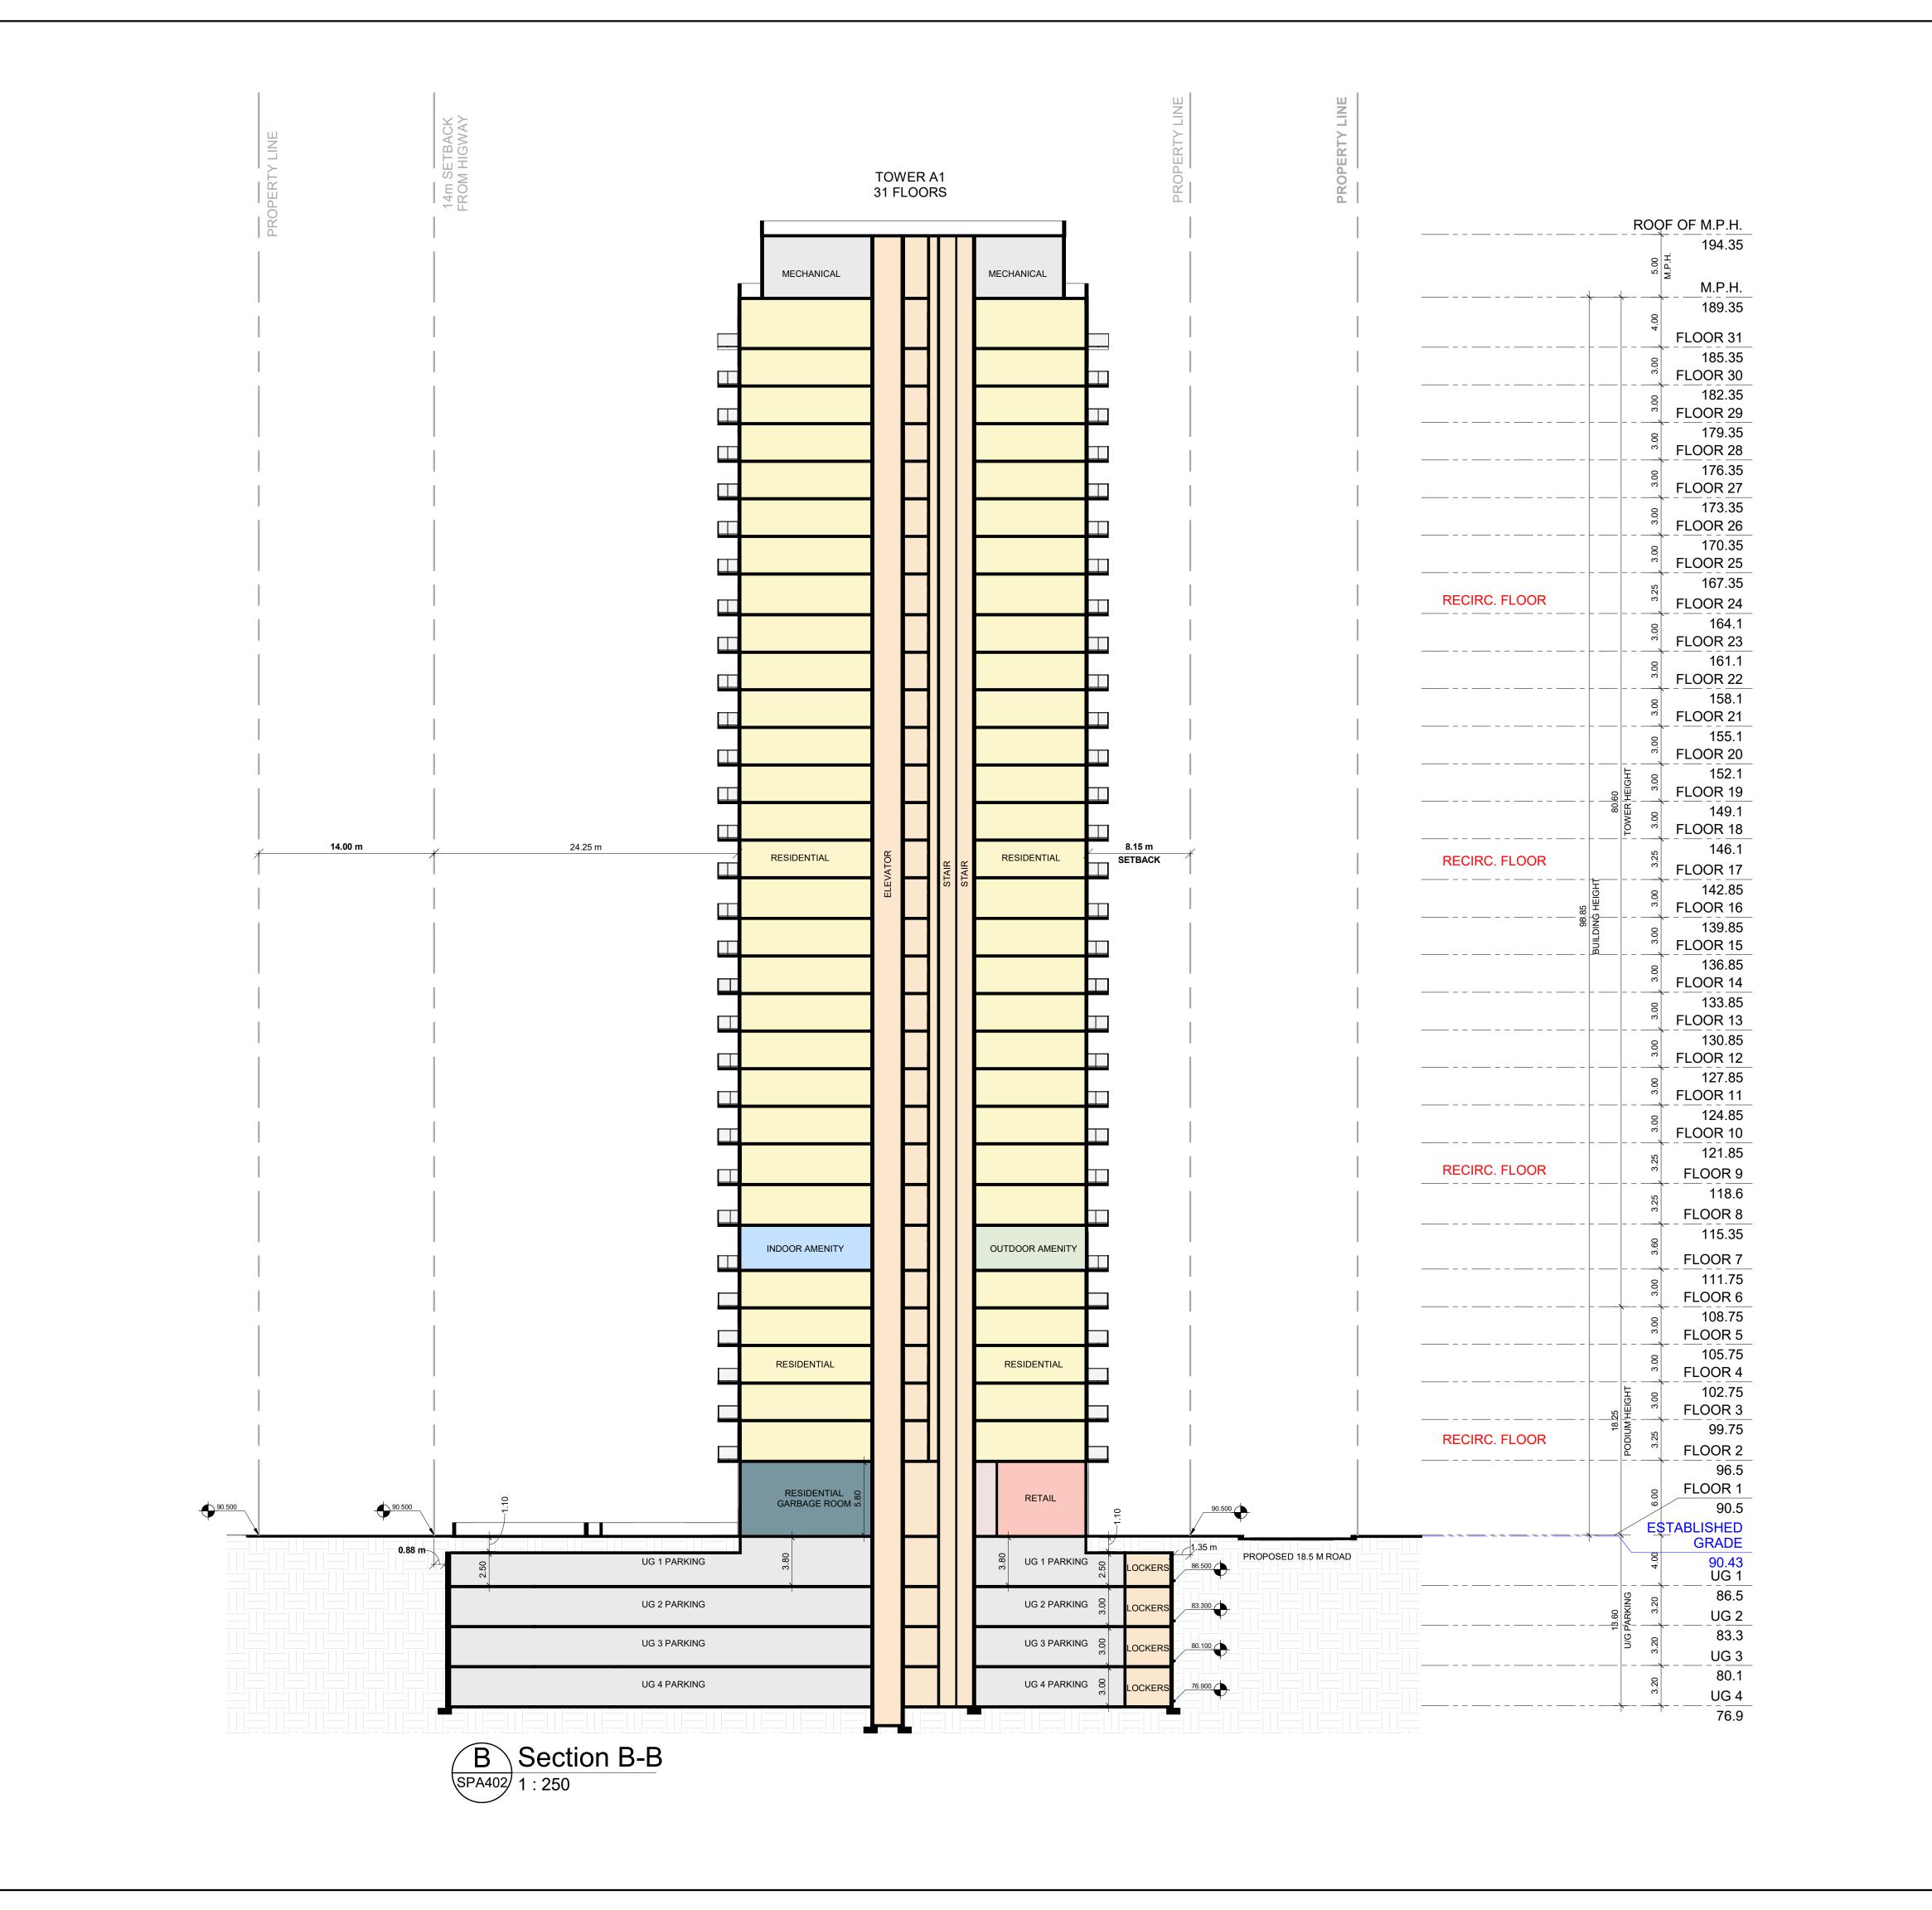

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PICKERING DESIGN CENTRE (BLOCK 1)

1775 PICKERING PARKWAY PICKERING, ON.

DRAWING

BUILDING SECTIONS


PROJECT NO.
06.037RZ
PROJECT DATE
2022-05-12
DRAWN BY
TKA

CHECKED BY AYU SCALE


1:250

ASSOCIATION OF ARCHITECTS


ARUSSELL L.FLEISCHER
LICENCE
5004

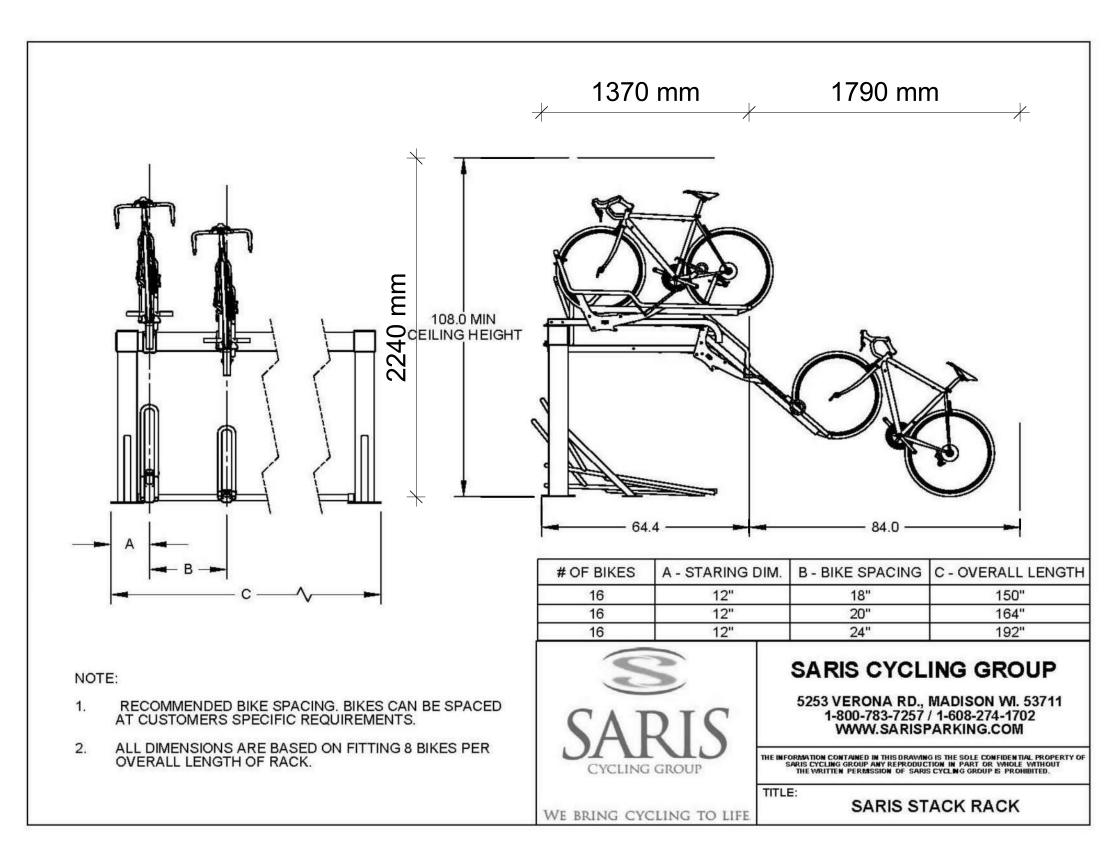


SPECIFICATIONS OF SARIS HORIZONTAL STACKED BICYCLE PARKING SPACES

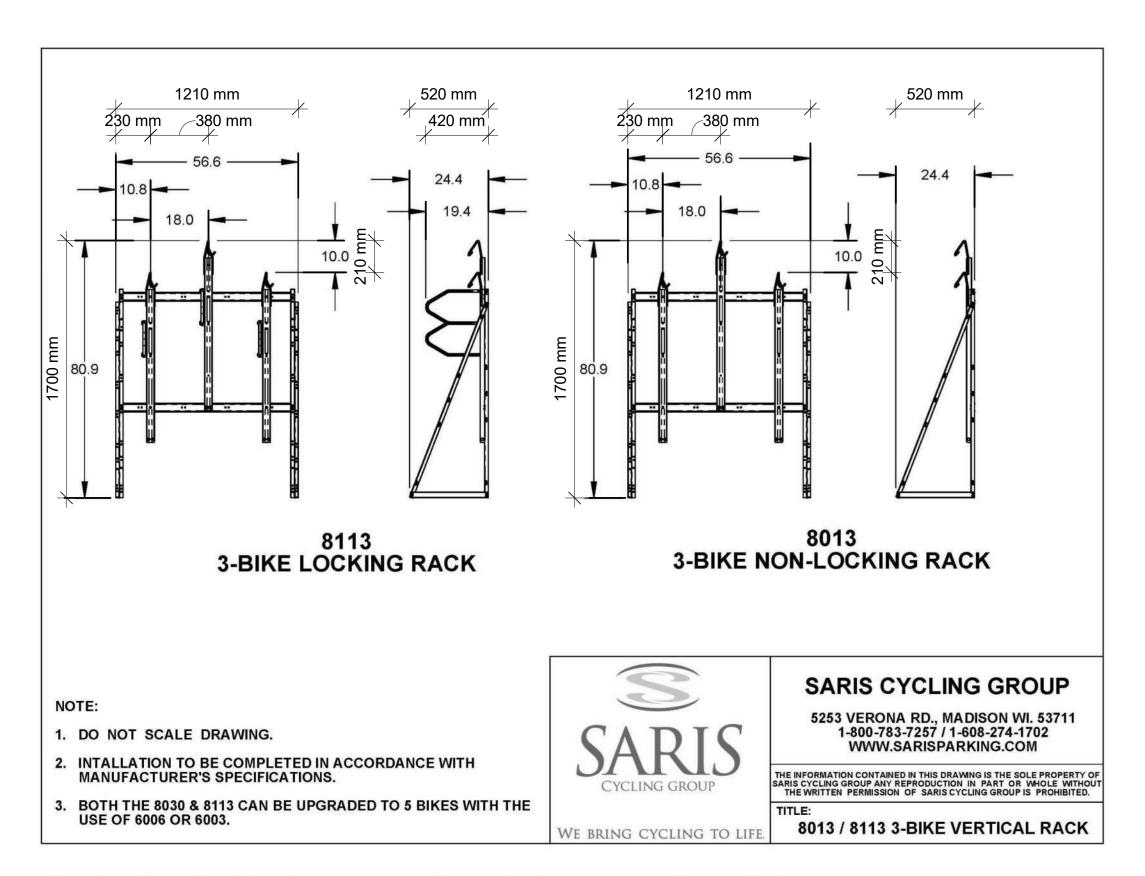

SPECIFICATIONS OF SARIS VERTICAL BICYCLE PARKING SPACES

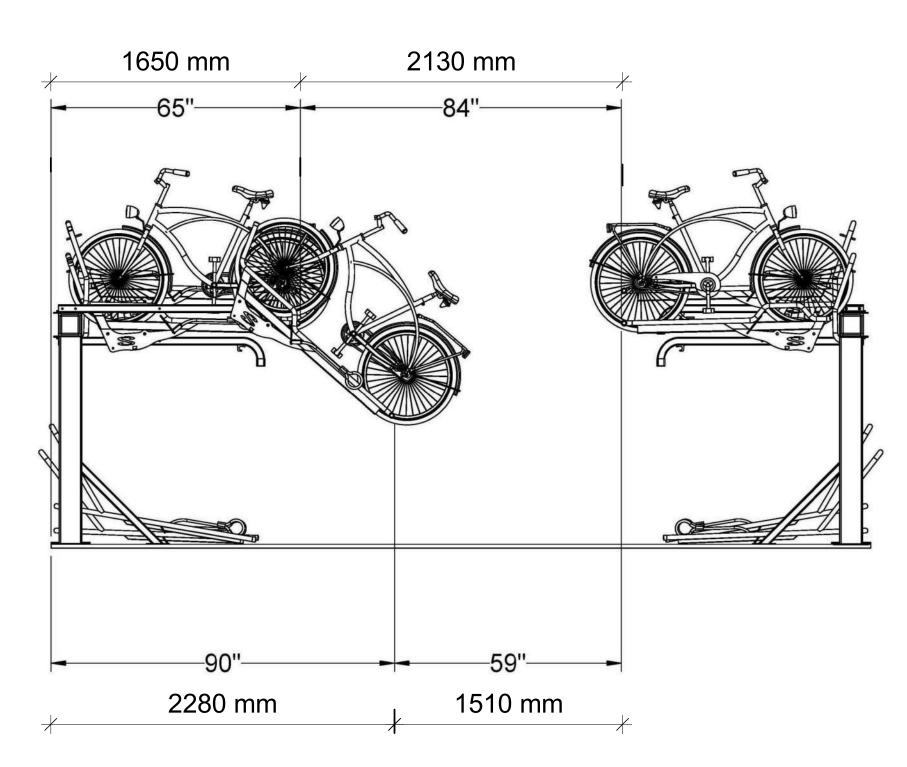

SECTION OF SARIS HORIZONTAL STACKED BICYCLE PARKING SPACES

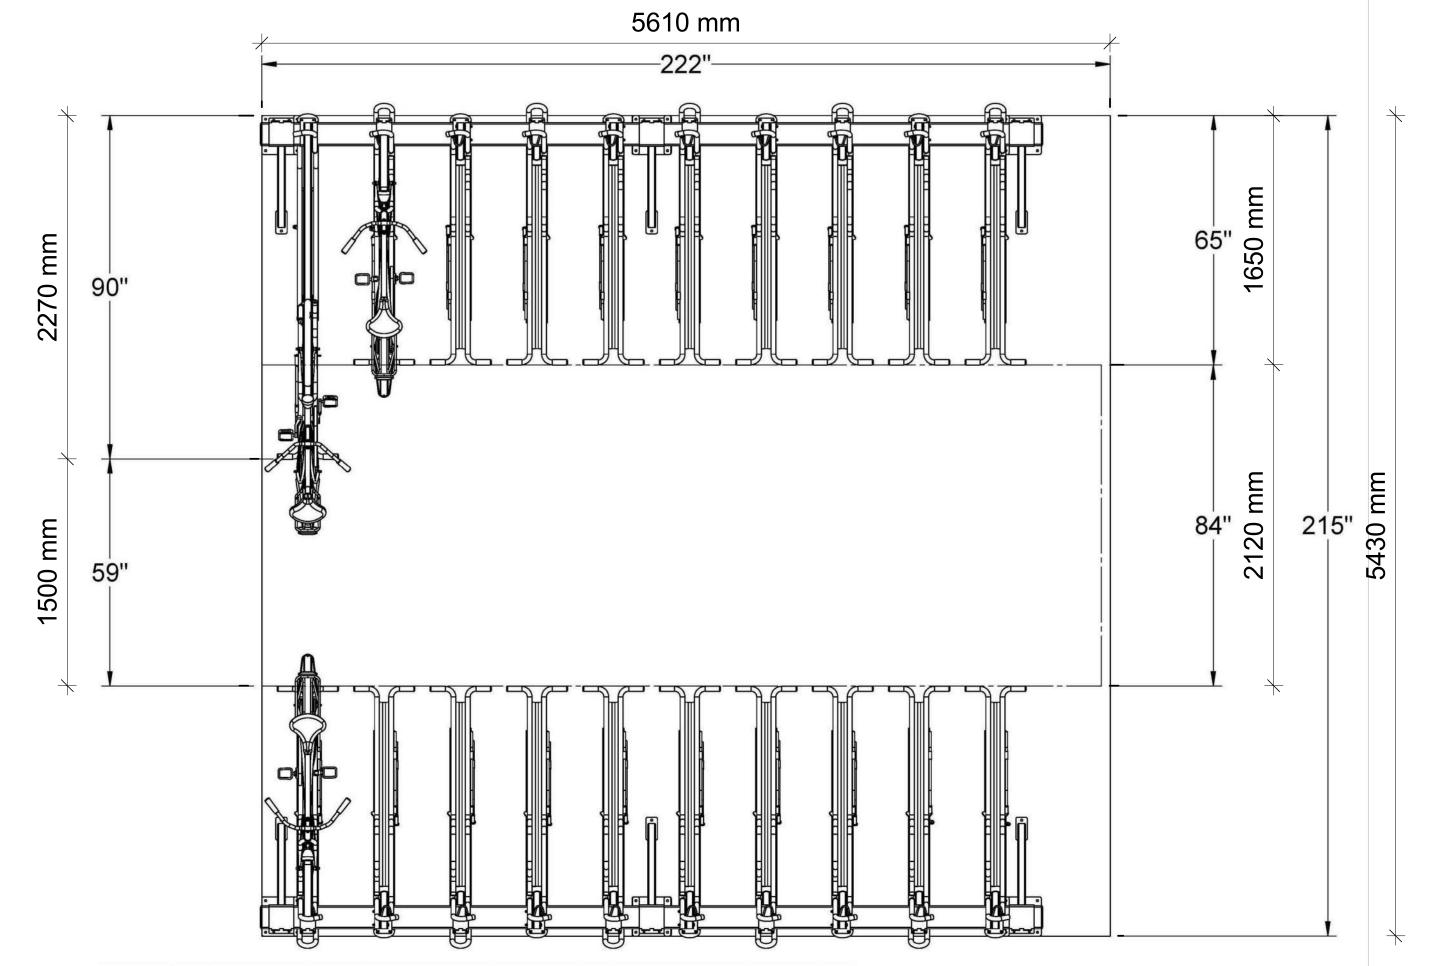

PLAN OF SARIS HORIZONTAL STACKED BICYCLE PARKING SPACES



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DATE DESCRIPTION

BAYFIELD
Realty Advisors Inc.

PICKERING DESIGN CENTRE (BLOCK 1)

1775 PICKERING PARKWAY PICKERING, ON.

DETAILS (SARIS BIKE RACK)

PROJECT NO.
06.037RZ
PROJECT DATE
2022-05-12
DRAWN BY
TKA
CHECKED BY
AYU
SCALE

1:25

ASSOCIATION OF OF ARCHITECTS Z

ARCSELL L,FLEISCHER III
LICENCE
5004



VIEW FROM RIGHT-OF-WAY LOOKING SOUTH

TURNER FLEISCHER

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PICKERING DESIGN CENTRE (BLOCK 1)

> 1775 PICKERING PARKWAY PICKERING, ON.

DRAWING

3D PERSPECTIVES

PROJECT NO.
06.037RZ
PROJECT DATE
2022-05-12
DRAWN BY
TKA

ASSOCIATION OF OF ARCHITECTS O



VIEW FROM RIGHT OF WAY LOOKING SOUTH

TURNER FLEISCHER

67 Lesmill Road Toronto, ON, M3B 2T8 T 416 425 2222

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PICKERING DESIGN CENTRE (BLOCK 1)

> 1775 PICKERING PARKWAY PICKERING, ON.

DRAWING

3D PERSPECTIVES

3D PERSPECTIVES

PROJECT NO.
06.037RZ
PROJECT DATE
2022-05-12
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VIEW FROM RIGHT-OF-WAY LOOKING NORTH WEST



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DATE



PICKERING DESIGN CENTRE (BLOCK 1)

1775 PICKERING PARKWAY PICKERING, ON.

3D PERSPECTIVES

PROJECT NO. 06.037RZ 2022-05-12 CHECKED BY AYU SCALE



VIEW OF SOUTH OF SIGHT LOOKING NORTH WEST

TURNER FLEISCHER

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